

BIRD BUILDING ROOF REPLACEMENT  
WESTERN CAROLINA UNIVERSITY  
108 BIRD BUILDING LANE, CULLOWHEE, NC 28723  
WCU PR#: 2022-017  
SCO ID#: 22-25374-01A

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SKA JOB NUMBER: 220533.0

DRAWING SYMBOL LEGEND  
NO SCALE  
Dwg # 220533-G1000.DWG

COLUMN GRID DESIGNATION

INDICATES DIRECTION OF VIEW

SECTION NUMBER

SHEET WHERE SECTION IS DRAWN

INDICATES DIRECTION OF VIEW

ELEVATION NUMBER

SHEET WHERE ELEVATION IS DRAWN

DETAIL NUMBER

SHEET WHERE DETAIL IS DRAWN

INDICATES AREA SHOWN IN DETAIL

MATERIALS AND SYMBOLS LEGEND  
Dwg # 220533-G1000.DWG

BRICK (SECTION)	PLYWOOD (SECTION)	ITEM TO BE DEMOLISHED	WOOD (NEW CONTINUOUS)
BRICK (ELEVATION)	FIBERBOARD	INSULATION (RIGID)	WOOD (EXISTING CONTINUOUS)
CONCRETE	EARTH/SOIL	STEEL	
CMU (SECTION)	FILL GROUT/ MORTAR	STONE FILL	
CMU (ELEVATION)	GYPSUM BOARD	TECTUM ROOF DECK	
LIGHT WEIGHT CONCRETE INSULATION	INSULATION (BATT)	WOOD (FINISH)	



AERIAL VIEW  
N.T.S.  
Dwg # 220533-G1000.DWG

ABBREVIATIONS			
Dwg # 220533-G1000.DWG			
A.B.	ANCHOR BOLT	FT.	FOOT; FEET
ACI	AMERICAN CONCRETE INSTITUTE	FTG.	FOOTING
A.F.F.	ABOVE FINISHED FLOOR	G.B.	GRADE BEAM
AISC	AMERICAN INSTITUTE OF STEEL CONSTRUCTION	GA.	GAGE; GAUGE
AITC	AMERICAN INSTITUTE OF TIMBER CONSTRUCTION	GALV.	GALVANIZED
ALT.	ALTERNATE	H.M.	HOLLOW METAL
ARCH.	ARCHITECTURAL	H.S.	HIGH STRENGTH
ASTM	AMERICAN SOCIETY FOR TESTING AND MATERIALS	HEX. HD.	HEXAGONAL HEAD
AVG.	AVERAGE	HSS	HOLLOW STRUCTURAL SHAPE
AWS	AMERICAN WELDING SOCIETY	HT.	HEIGHT
BLDG.	BUILDING	I.D.	INSIDE DIAMETER
BM.	BEAM	I.F.	INSIDE FACE
B.P.	BEARING PLATE; BASE PLATE	IN.	INCHES
BRG.	BEARING	IBC	INTERNATIONAL BUILDING CODE
C.J.	CONSTRUCTION JOINT	INT.	INTERIOR; INTERSECTION
CMU	CONCRETE MASONRY UNIT	JST.	JOIST
CGS	CENTER OF GRAVITY OF STEEL	JT.	JOINT
CL.	CENTERLINE	K	KIP (1,000 LBS.)
CLG.	CLEAR	K/FT	KIPS PER FOOT
CLR.	CLEAR	LLBB	LONG LEGS BACK TO BACK
COL.	COLUMN	LLH	LONG LEG HORIZONTAL
CONC.	CONCRETE	LLO	LONG LEG OUTSTANDING
CONN.	CONNECTION	LLV	LONG LEG VERTICAL
CONST.	CONSTRUCTION	L.W.	LONG WAY
CONT.	CONTINUOUS	L.B.	POUND
CRSI	CONCRETE REINFORCING STEEL INSTITUTE	L.G.	LONG
CTR.	CENTER	LIN.	LINEAR
D.C.J.	DOWELED CONTROL JOINT	LL	LIVE LOAD
D.J.	DOUBLE JOIST	LT. WT.	LIGHT WEIGHT
D.S.	DOWN SPOUT	M.O.S.	MIDDLE OF SLAB
DBL.	DOUBLE	M.O.W.	MIDDLE OF WALL
DET.	DETAIL	MATL.	MATERIAL
DIA.	DIAMETER	MAX.	MAXIMUM
DIAG.	DIAGONAL	MIN.	MINIMUM
DIM.	DIMENSION	MISC.	MISCELLANEOUS
DL	DEAD LOAD	MK	MARK
DN.	DOWN	N/A	NOT APPLICABLE
DWG(S).	DRAWING(S)	N.F.	NEAR FACE
E.F.	EACH FACE	N.I.C.	NOT IN CONTRACT
E.S.	EACH SIDE	N.T.S.	NOT TO SCALE
E.W.	EACH WAY	N-S	NORTH-SOUTH
E-W	EAST-WEST	NCSC	NORTH CAROLINA STATE BUILDING CODE
EA.	EACH	NFPA	NATIONAL FIRE PROTECTION ASSOCIATION
ELEV.	ELEVATION; ELEVATOR	NO.	NUMBER
ENGOR.	ENGINEER	NOM.	NOMINAL
EPDM	ETHYLENE PROPYLENE DIENE MONOMER	O/C	ON CENTER
EQ.	EQUAL	O.D.	OUTSIDE DIAMETER
EXIST.	EXISTING		
EXP. JT.	EXPANSION JOINT		
EXT.	EXTERIOR		
F.D.	FLOOR DRAIN		
F.F.	FAR FACE		
FIN.	FOUNDATION		
FIN.	FINISH		
FL.	FLOOR		
FLG.	FLANGE		
F.O.B.	FACE OF BRICK		

O.F.	OUTSIDE FACE
OPNG.	OPENING
OPP.	OPPOSITE
O.H.	OPPOSITE HAND
ORIG.	ORIGINAL
P/S	PRESTRESSED
P/T	POST-TENSIONING
P.C.	PRECAST CONCRETE
PCI	PRESTRESSED CONCRETE INSTITUTE
PEN.	PENETRATION
PERP.	PERPENDICULAR
PL.	PLATE
PSF	POUNDS PER SQUARE FOOT
PSI	POUNDS PER SQUARE INCH
P.T.	PRESSURE TREATED
PTI	POST-TENSIONING INSTITUTE
PVC	POLYVINYL CHLORIDE
R.	RADIUS
R.D.	ROOF DRAIN
REF.	REFERENCE
REINF.	REINFORCE(D); REINFORCING
REM.	REMAINING; REMAINDER
REQ'D.	REQUIRED
S.S.D.	SATURATED SURFACE DRY
S.J.	SAVED JOINT
S.S.	STAINLESS STEEL
S.W.	SHORT WAY
SCHED.	SCHEDULE
SECT.	SECTION
SHT	SHEET
SIM	SIMILAR
SJI	STEEL JOIST INSTITUTE
SLBB	SHORT LEGS BACK TO BACK
SLO	SHORT LEG OUTSTANDING
S.O.G.	SLAB ON GRADE
SPEC(S).	SPECIFICATION(S)
SQ.	SQUARE
STD.	STANDARD
STL.	STEEL
STRUCT.	STRUCTURAL
SYM.	SYMMETRICAL
T.O.C.	TOP OF CONCRETE
T.O.F.	TOP OF FOOTING
T.O.S.	TOP OF SLAB; TOP OF STEEL
T.O.W.	TOP OF WALL
T&B	TOP AND BOTTOM
TEMP.	TEMPORARY
THRU	THROUGH
TYP.	TYPICAL
U.L.	UNDERWRITERS LABORATORIES
U.N.O.	UNLESS NOTED OTHERWISE
W/O	WITHOUT
W/	WITH
W.P.	WORKING POINT
W.W.F.	WELDED WIRE FABRIC
X	BY

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Printed: 2/15/2024 7:46:42 AM

Date:  
02-14-2024  
G1.0








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BIRD BUILDING ROOF REPLACEMENT  
 WESTERN CAROLINA UNIVERSITY  
 WCU PR#: 2022-17      SCO ID#: 22-25374-01A  
 E CULLOWHEE, NC

Designed By:	BDO
Drawn By:	JTH
Checked By:	BDO
Date:	02-14-2021

## R1.1

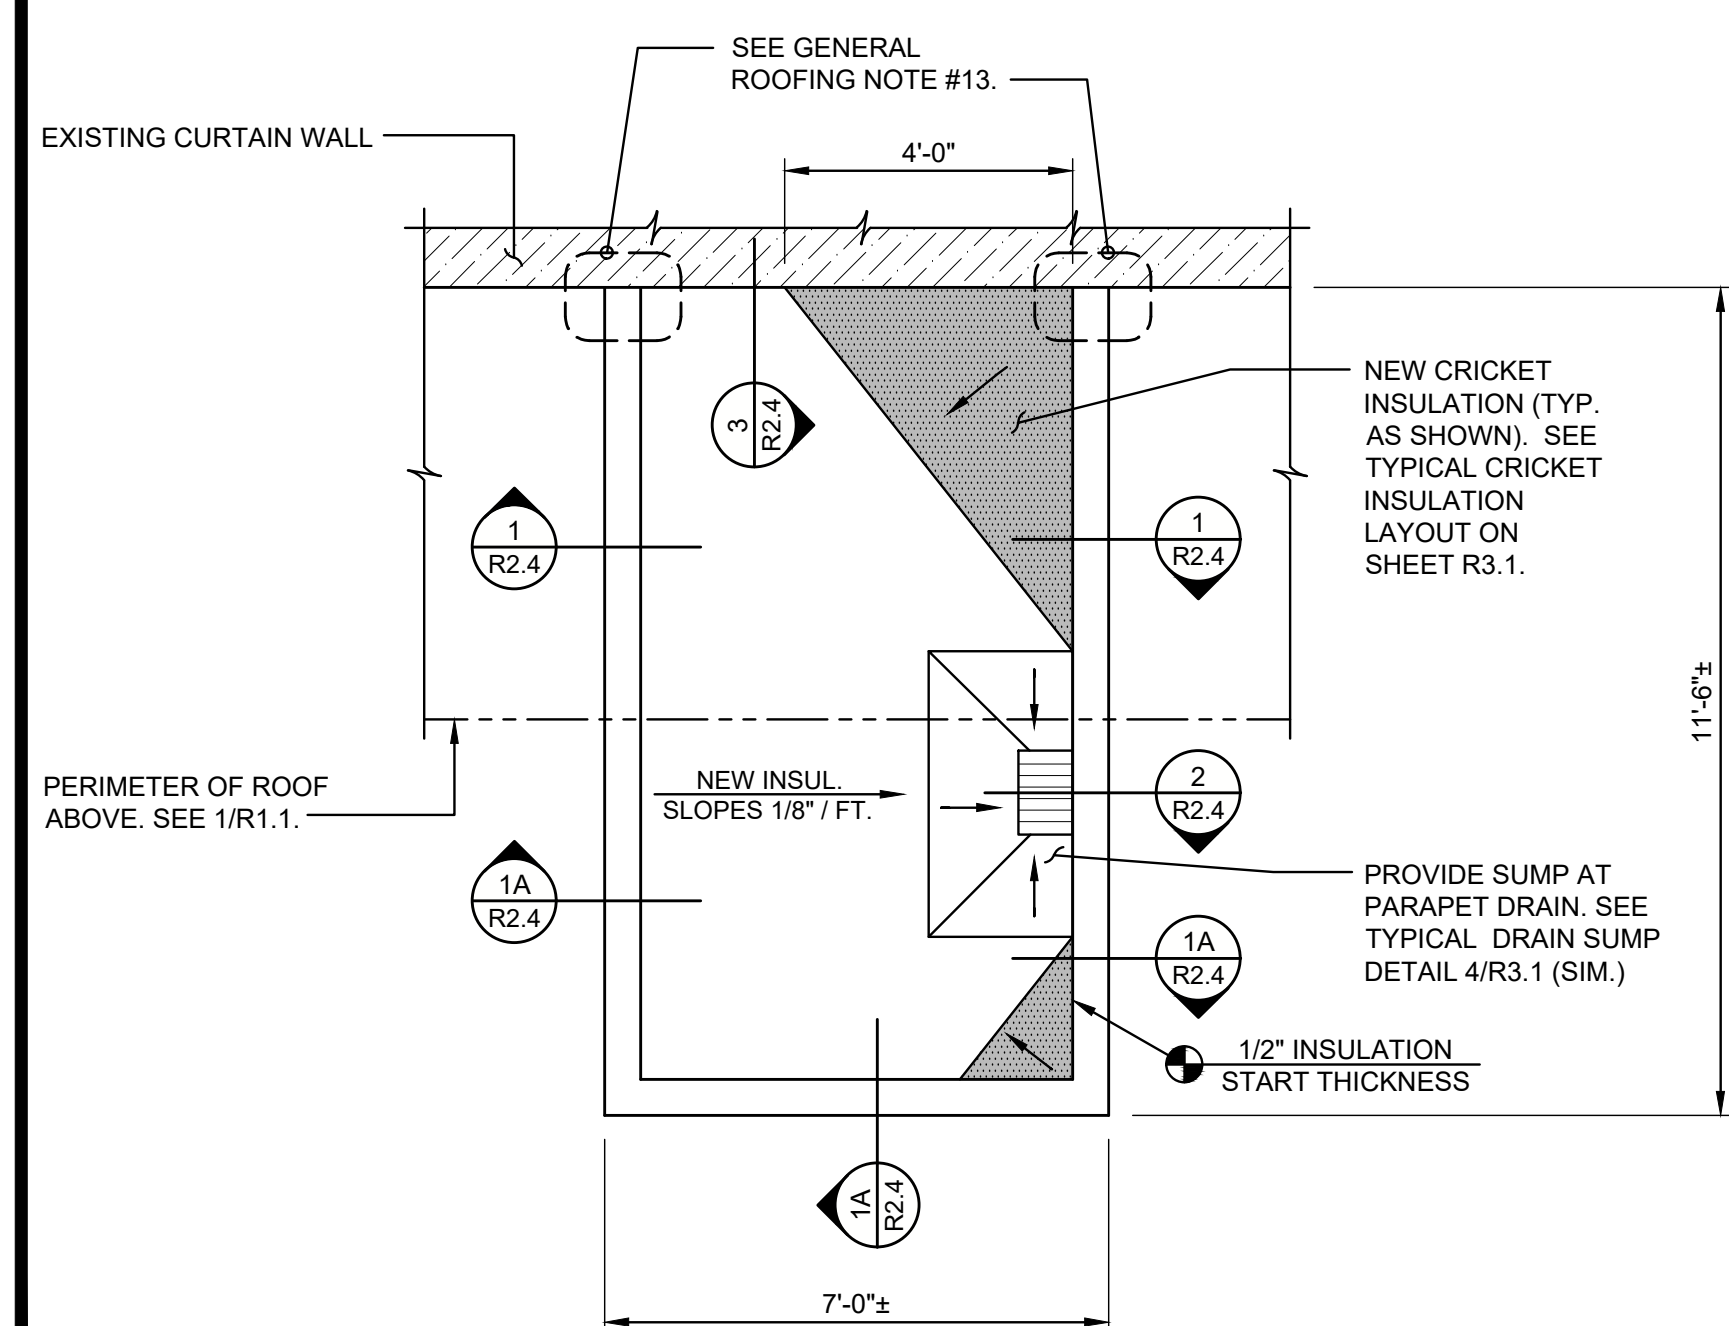


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R1.1






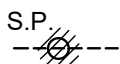
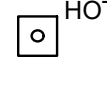
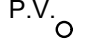

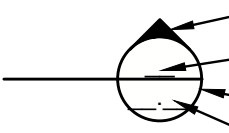

ENLARGED PLAN  
AT WEST ENTRANCE CANOPY ROOF

3/8" = 1'-0"  
DWG # 220533-R3001.DWG

R1.1  $3/16" = 1'-0"$   
DWG # 220513-R2001 DWG

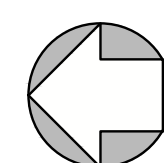


NO SCALE  
DWG # 230523-B-1001 DWG

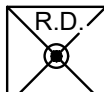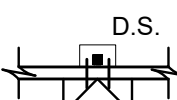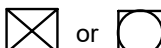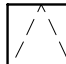- |   |       |   |
|---|-------|---|
|  | ..... | EXISTING ROOF DRAIN AND NEW ROOF DRAIN SUMP. SEE 5/R3.1.  |
|  | ..... | NEW COATED METAL PRIMARY SCUPPER, SCUPPER SUMP COLLECTOR HEAD AND DOWNSPOUT AT EXISTING LOCATIONS. SEE 4/R2.1 AND TYPICAL DOWNSPOUT ELEVATION (1/R3.2). |
|  | ..... | EXISTING ROOF CURB/ MECHANICAL VENT. SEE 6/R3.1.  |
|  | ..... | NEW ROOF HATCH AT EXISTING LOCATION. SEE 1/R2.3.  |
|  | ..... | EXISTING CAPPED ROOF CURB. SEE 6/R2.3.  |
|  | ..... | EXISTING ABANDONED STEEL SUPPORTS POST AND FRAMING TO BE REMOVED AND DISPOSED OF. SEE TYPICAL DECK CLOSURE DETAIL TR3.                                  |
|  | ..... | EXISTING HOT PIPE / HOT STACK. SEE 7/R3.1.  |
|  | ..... | EXISTING PIPE VENT. SEE 1/R3.1.   |
|  | ..... | EXISTING PIPE PENETRATION. SEE 2/R3.1.  |
|  | ..... | DIRECTION SECTION IS CUT.<br>SECTION NUMBER.<br>SECTION MARKER.<br>SHEET NUMBER.  |
|  | ..... | DIRECTION NEW THERMAL ROOF INSULATION SLOPES  |

CONSTRUCTION DOCUMENTS:




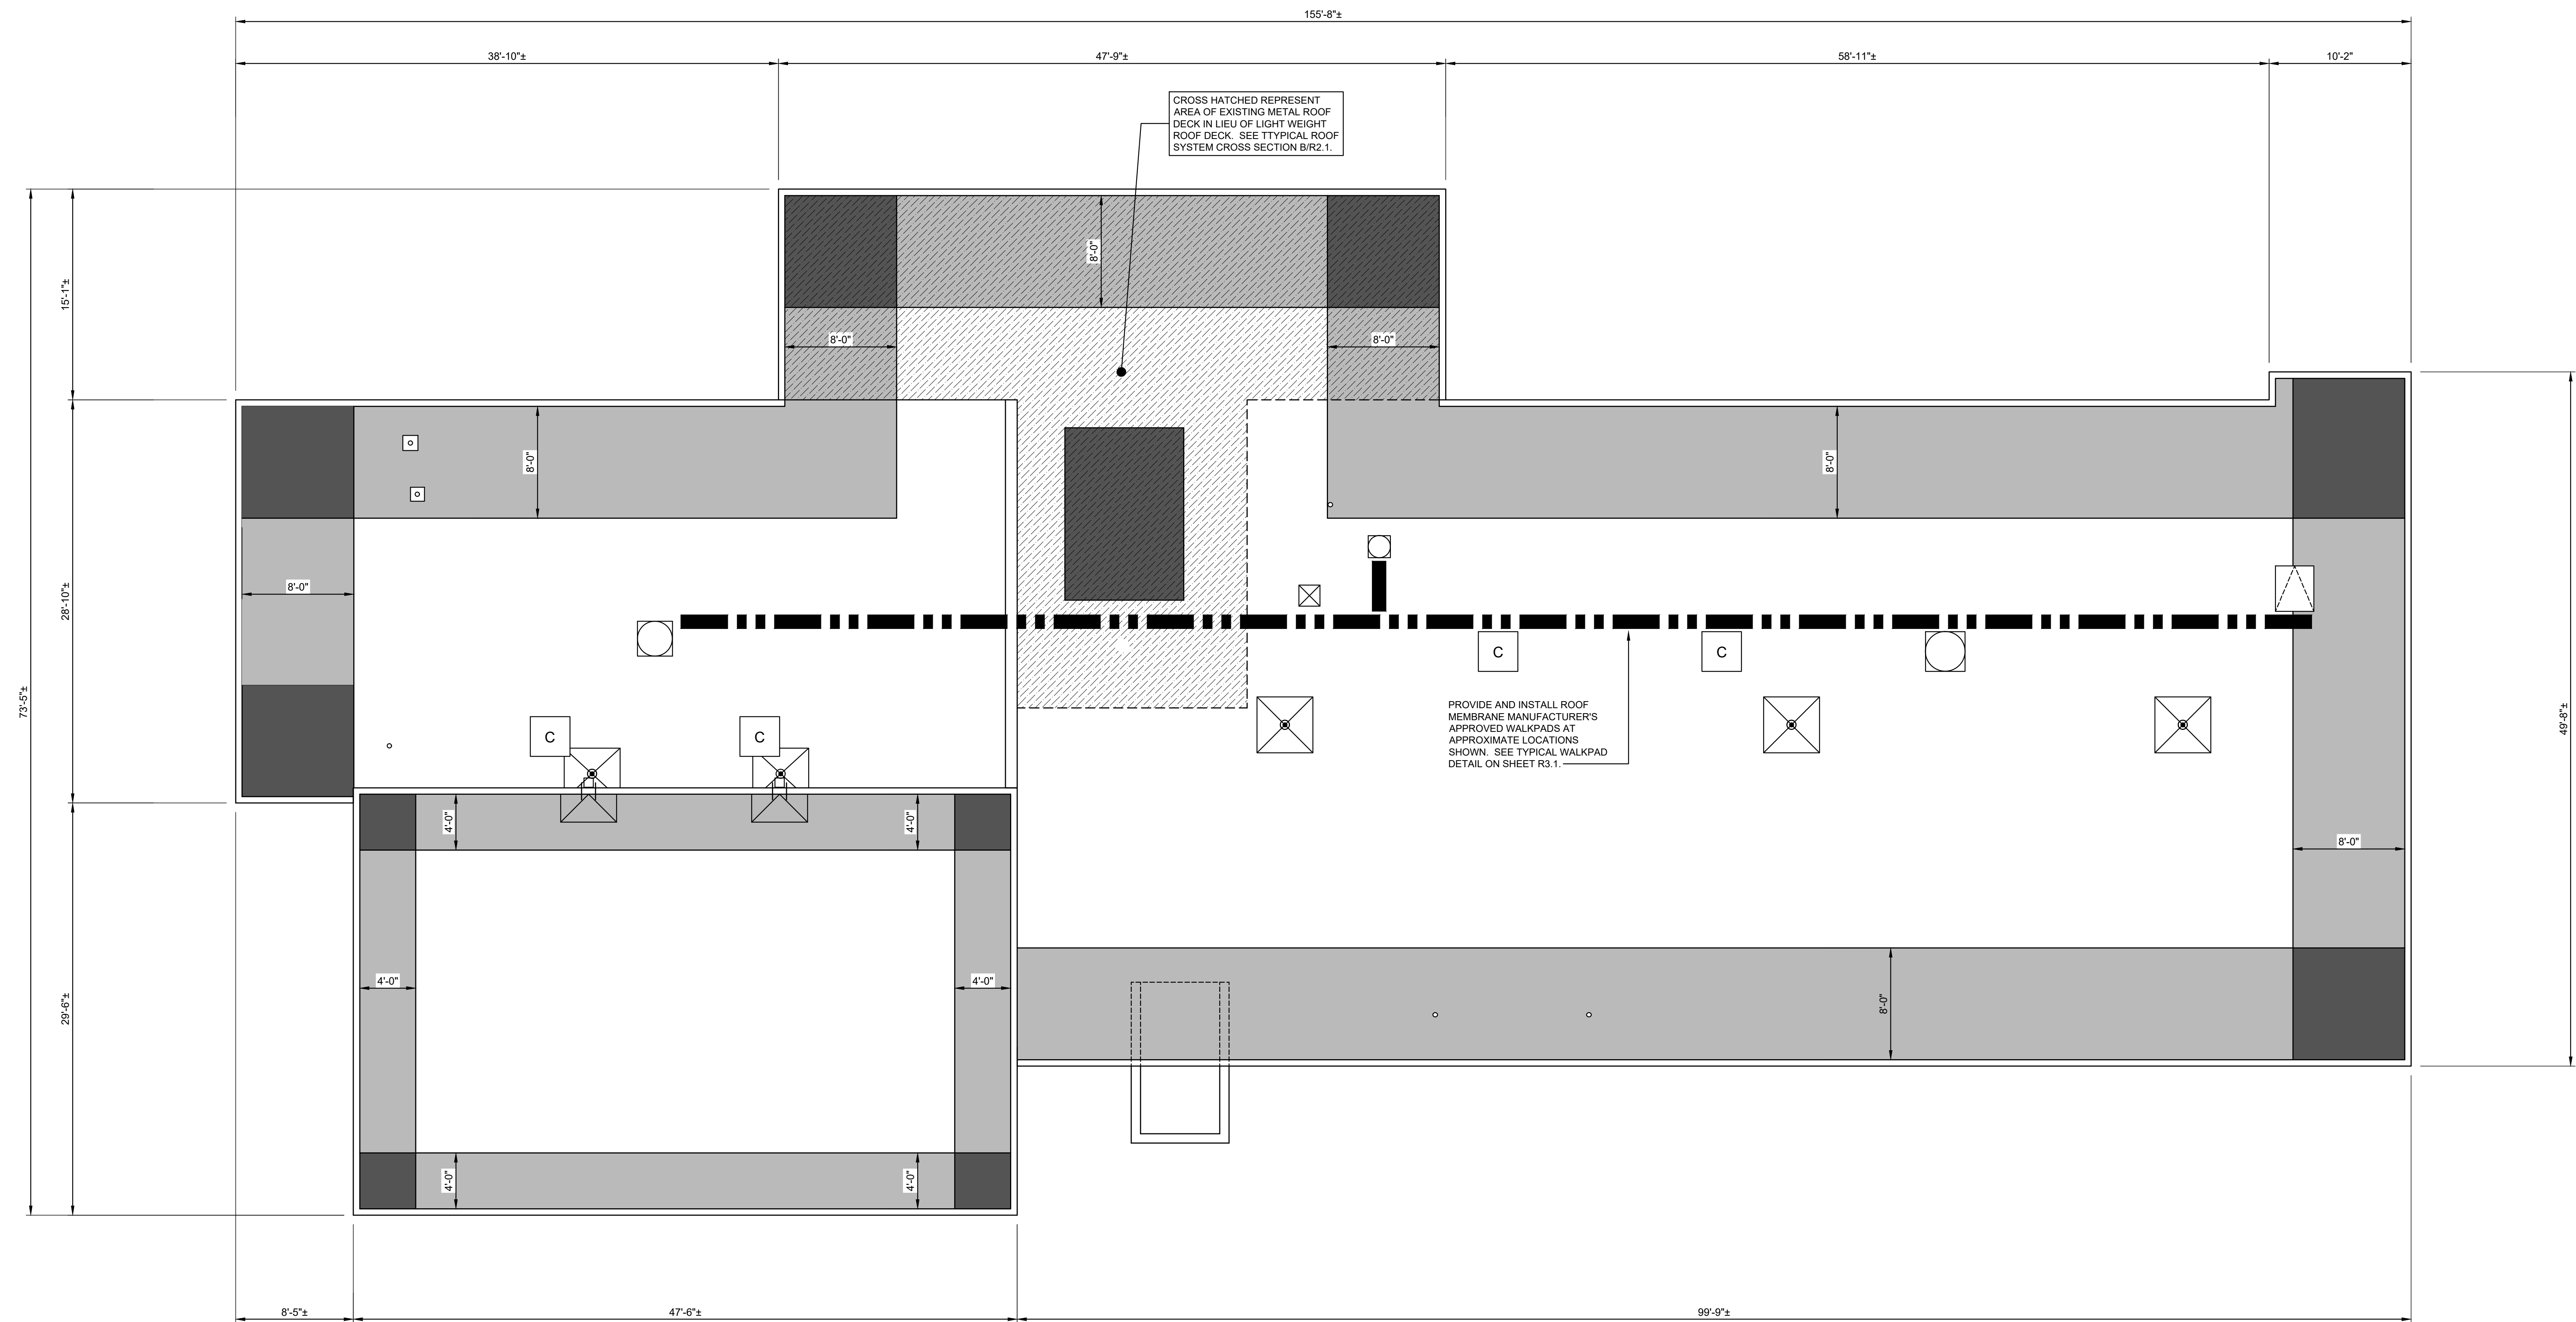

# 1 R1.2 ROOF PLAN - BIRD BUILDING(SECUREMENT ZONES & WALKPAD LAYOUT) 3/16" = 1'-0" Dwg #: 220533-R2001.DWG

### SECUREMENT PATTERN LEGEND

NO SCALE  
Dwg.# 220533-R1002.DWG

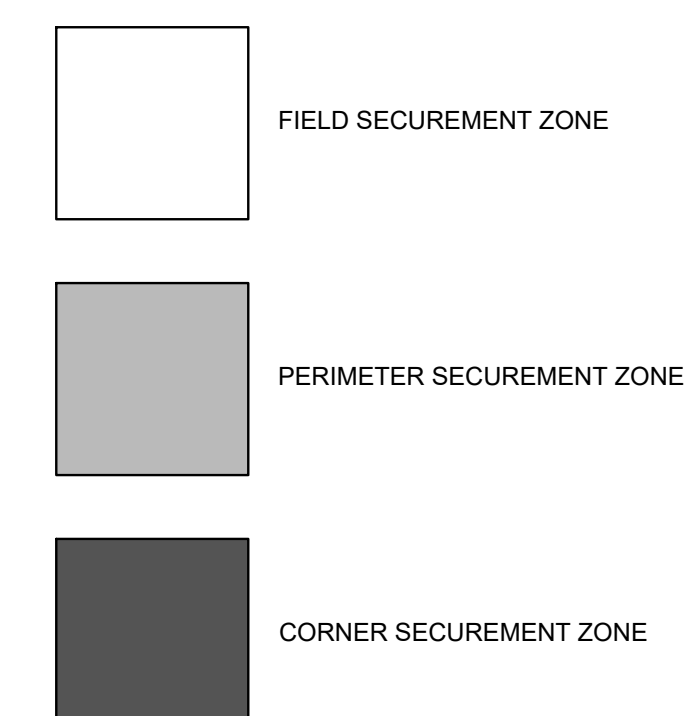

CONSTRUCTION DOCUMENTS:

108 BIRD BUILDING LANE  
CULLOWHEE, NORTH CAROLINA 28723  
WCU PR#: 2022-17 SCO ID#: 22-25374-01A  
WESTERN CAROLINA UNIVERSITY  
BIRD BUILDING ROOM TEL: 828.687.2222

Designed By:	BD0
Drawn By:	JTH
Checked By:	BD0
Date:	02-14-202


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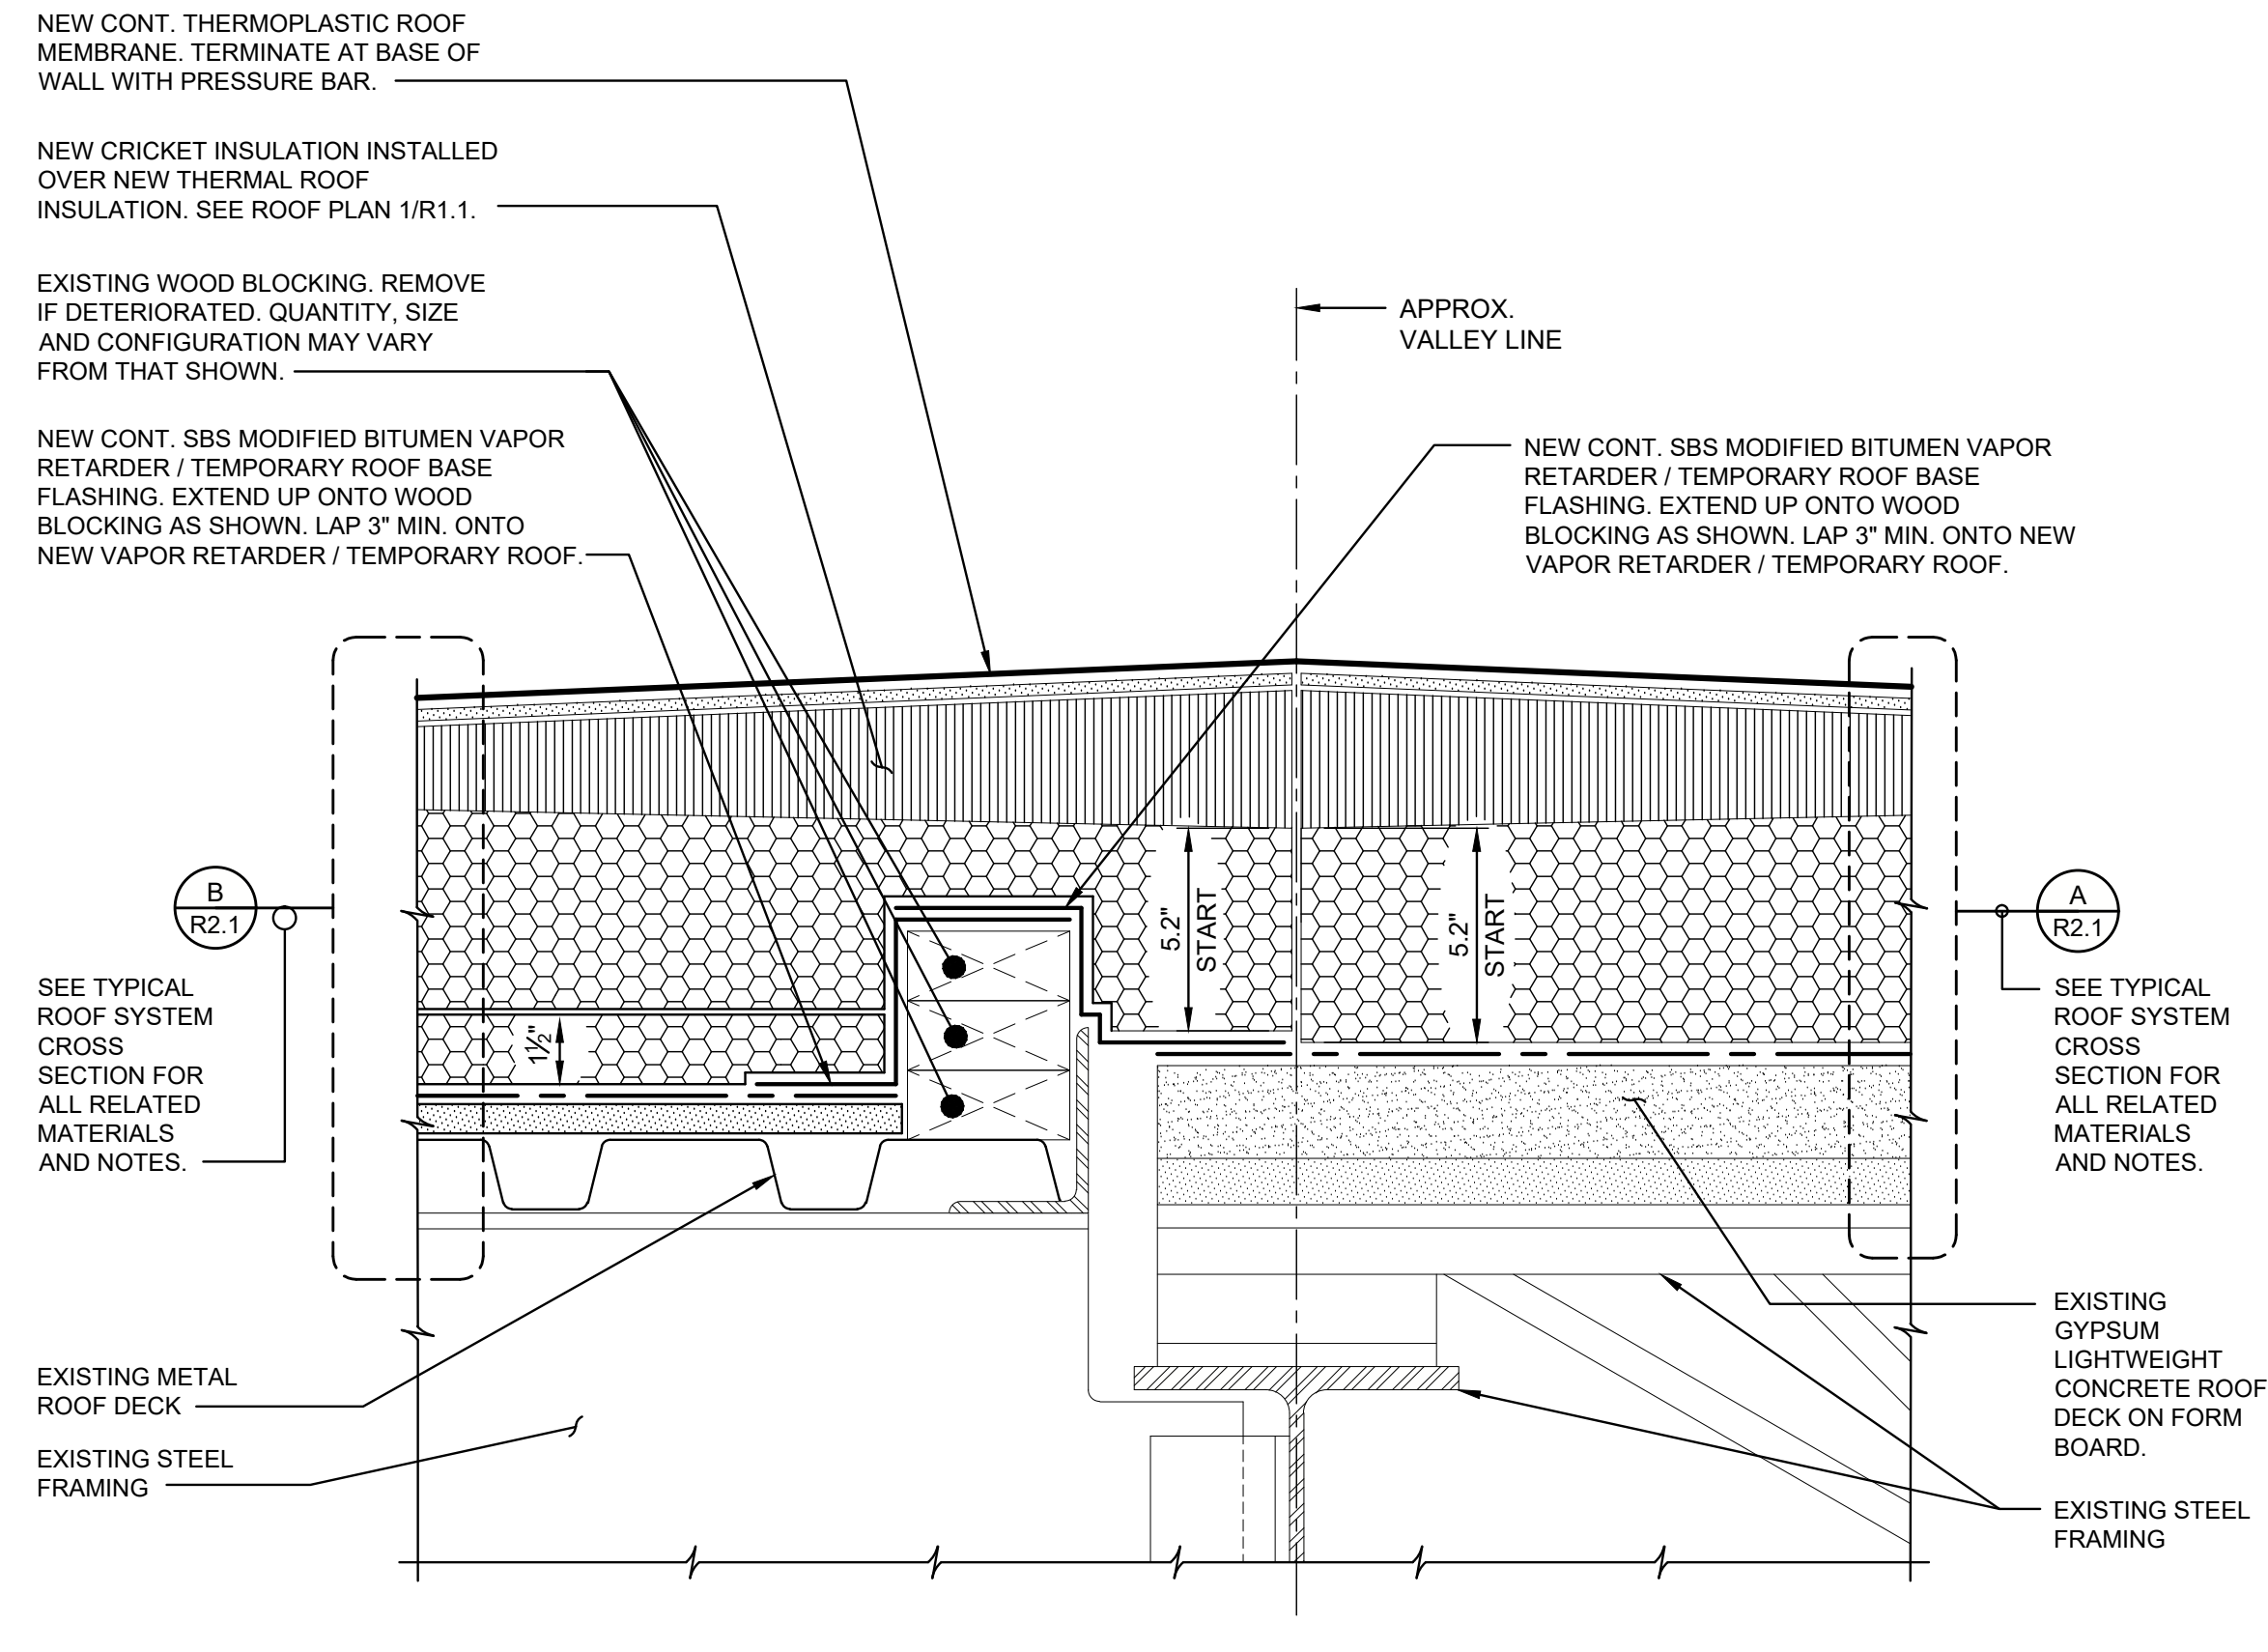










**1 SECTION - BASE OF WALL**  
R2.2  
3" = 1'-0"  
Dwg.# 220533-R6013.DWG

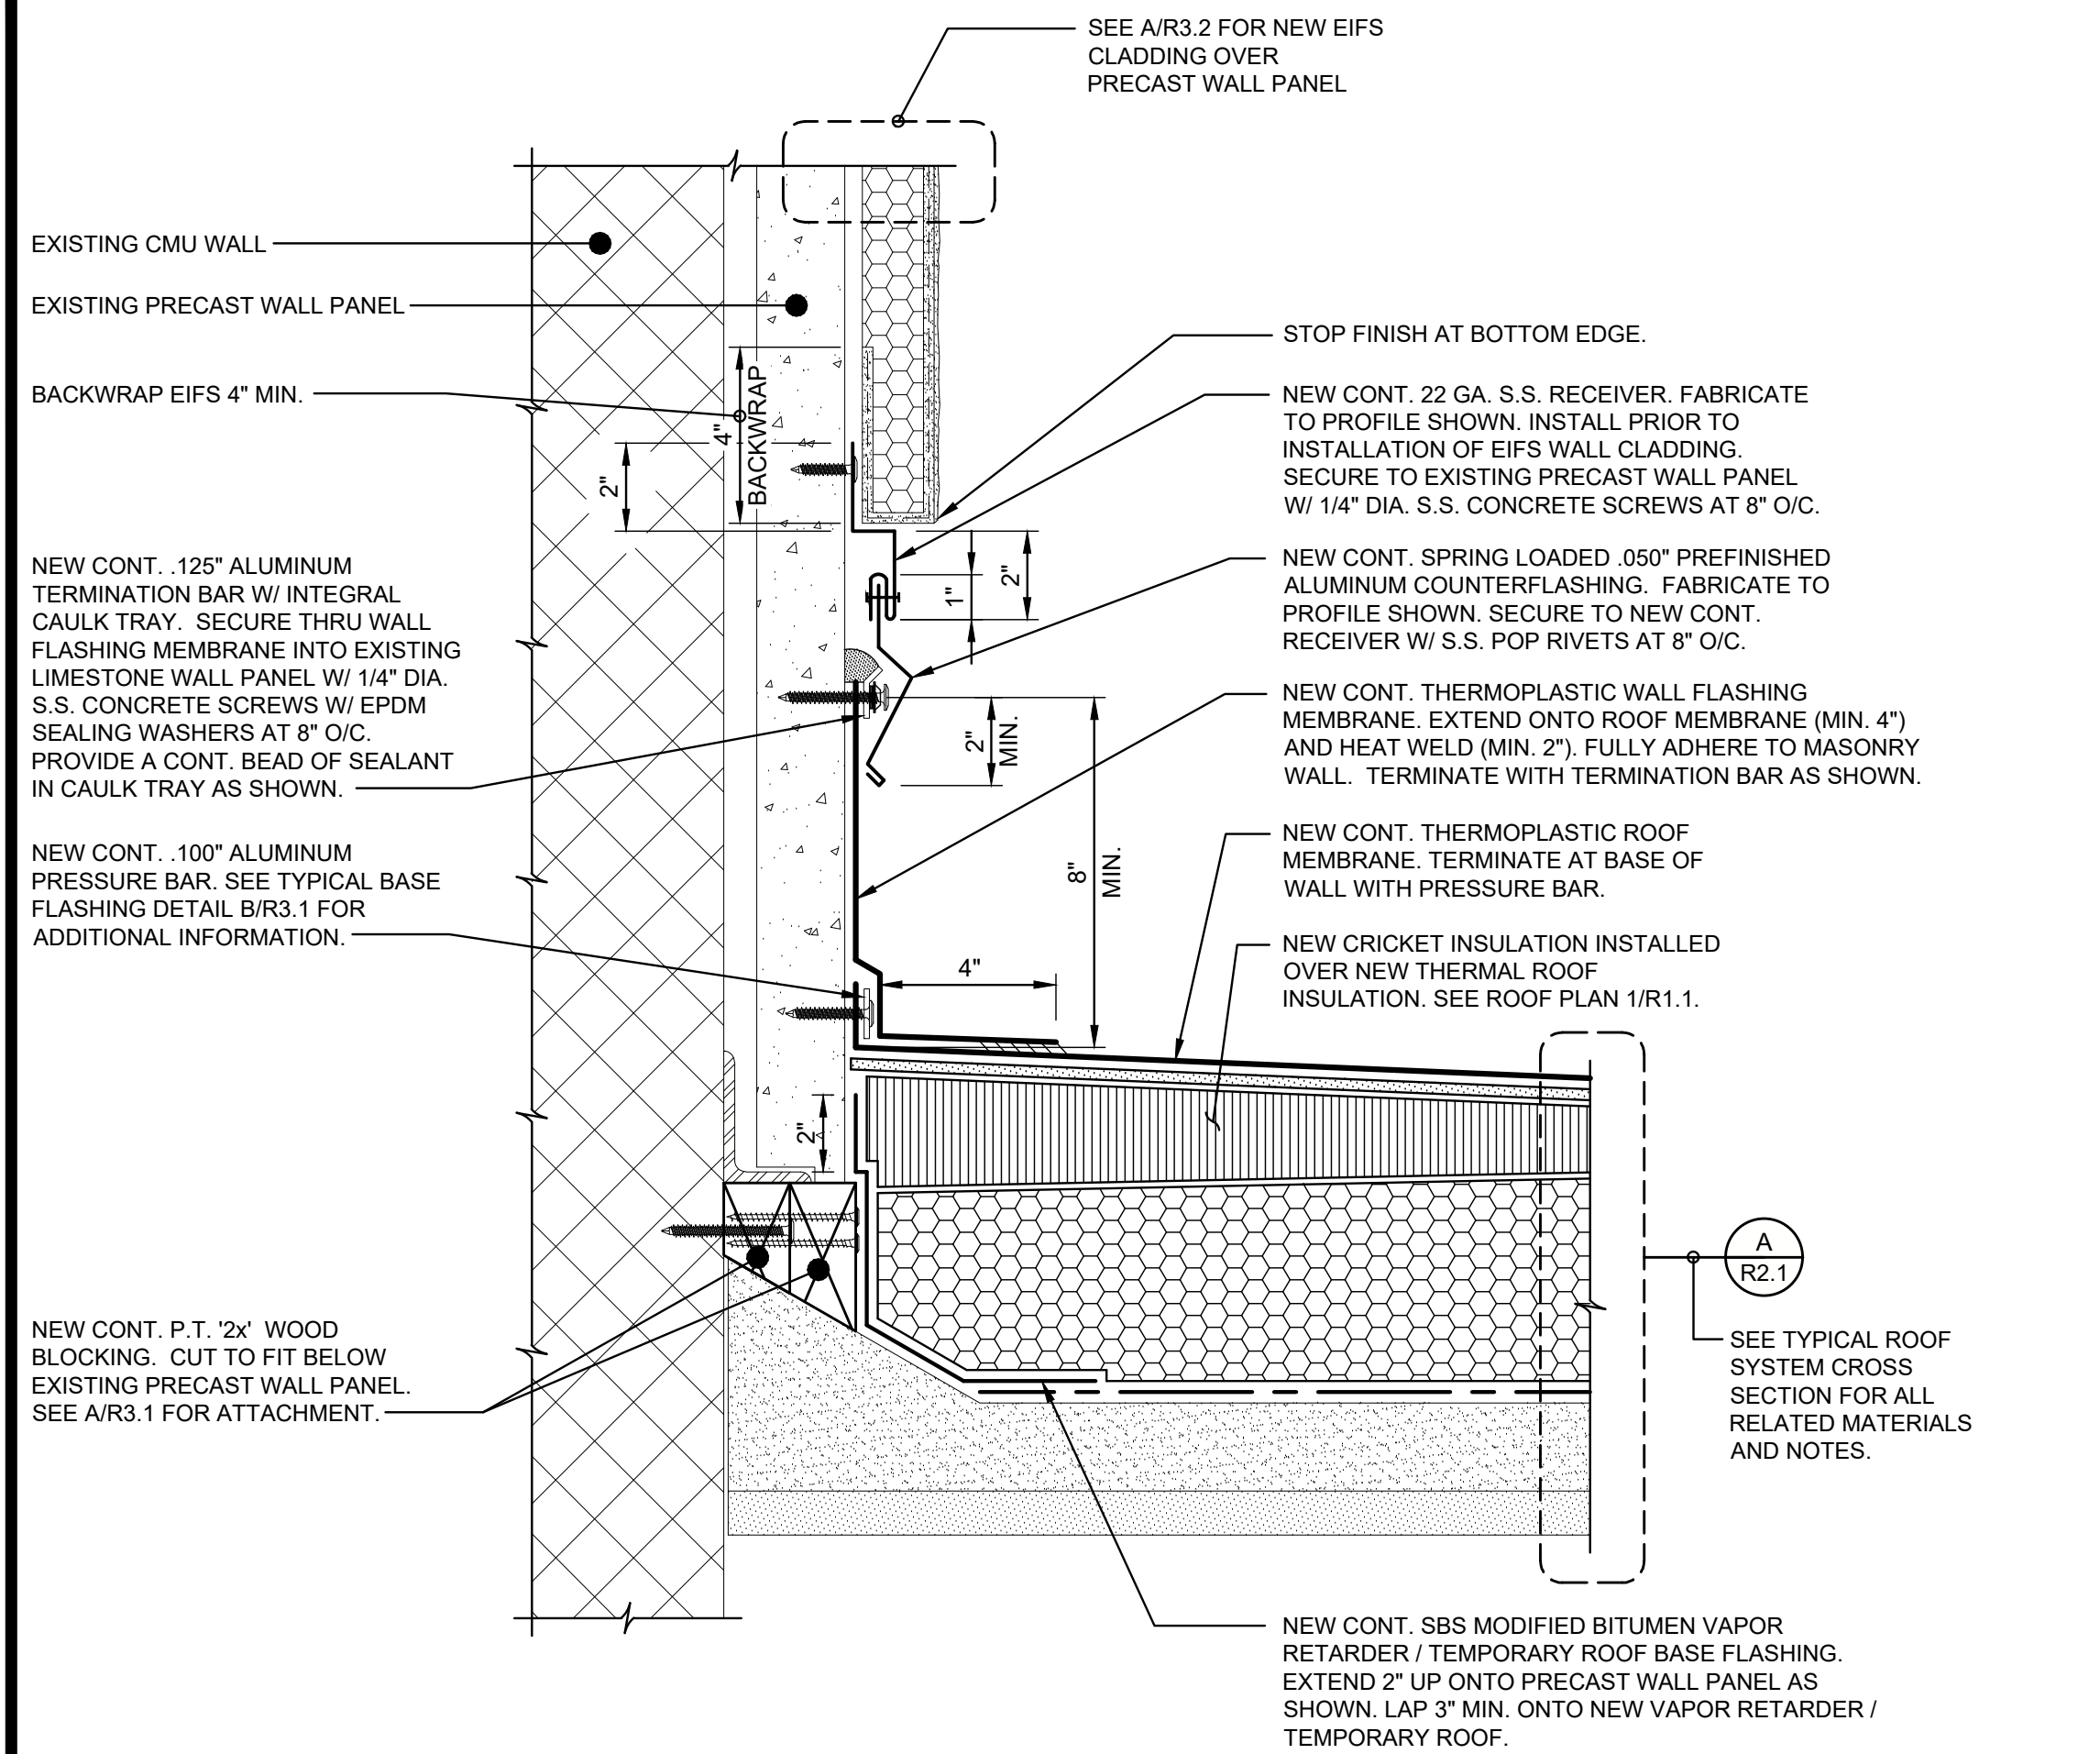


**2 SECTION - GYPSUM LIGHTWEIGHT DECK TO METAL DECK TRANSITION**  
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3" = 1'-0"  
Dwg.# 220533-R6014.DWG

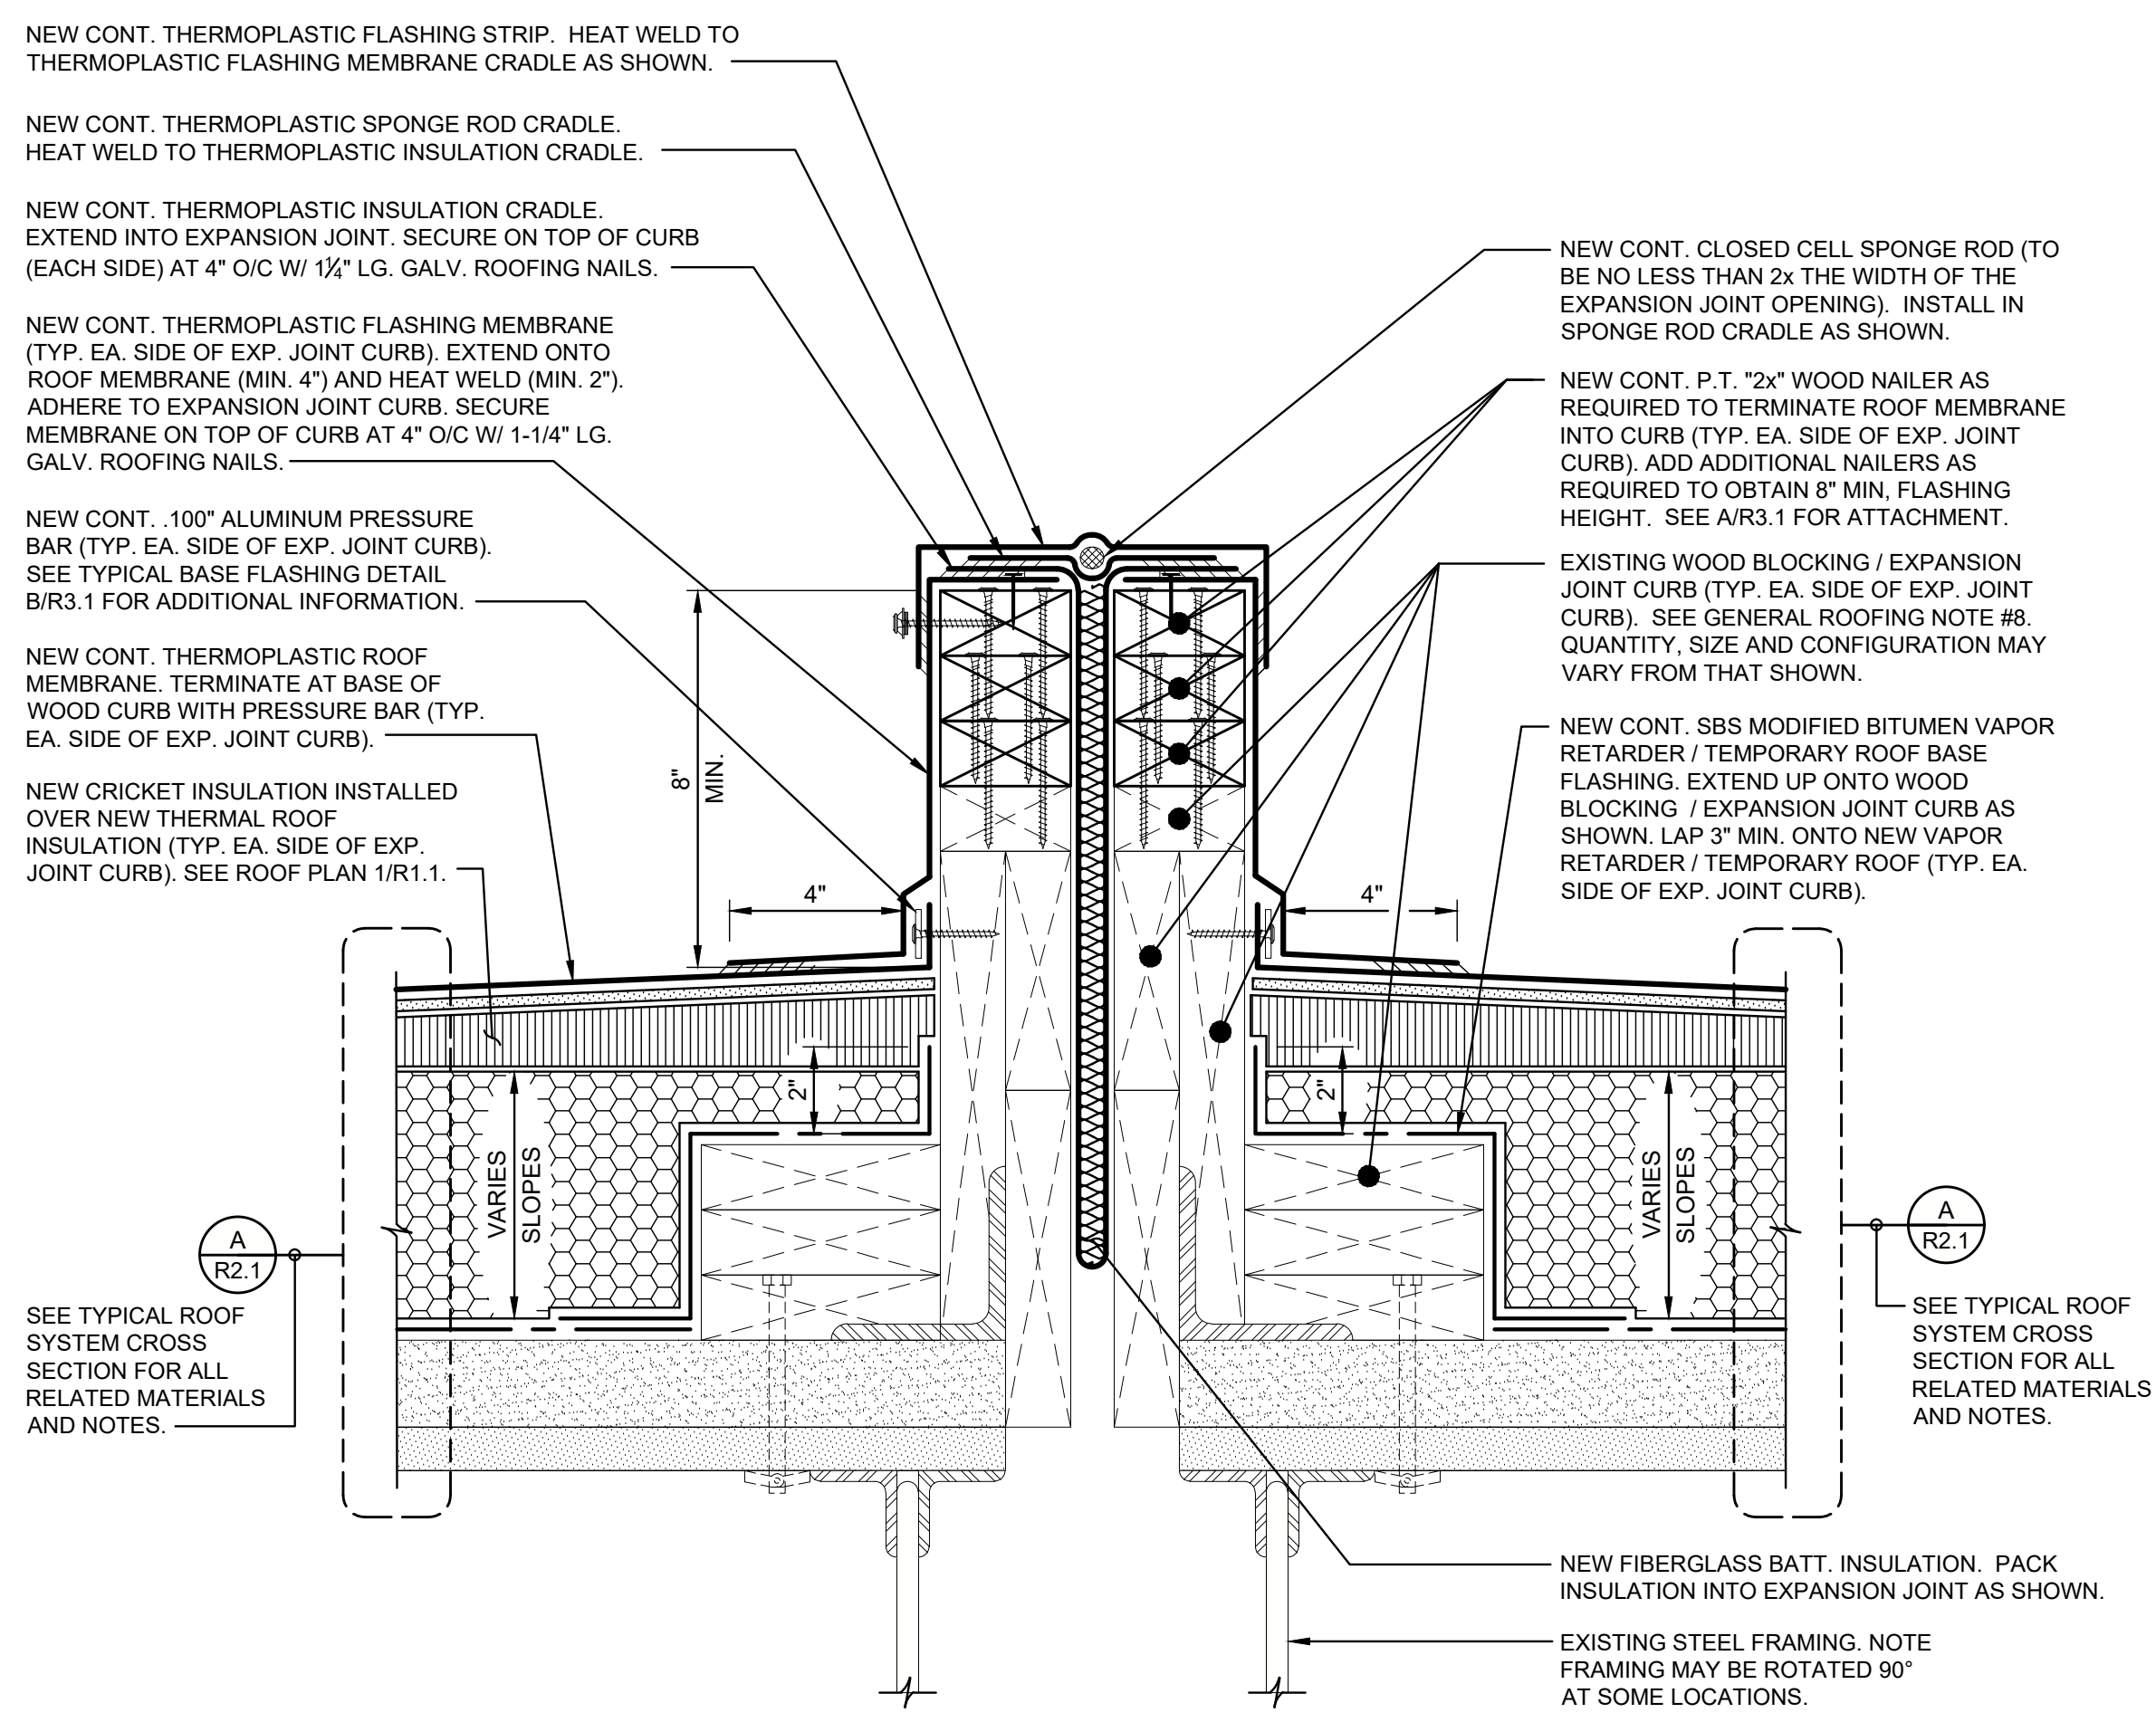


**3 SECTION - ROOF TO ROOF EXPANSION JOINT**  
R2.2  
3" = 1'-0"  
Dwg.# 220533-R6007.DWG

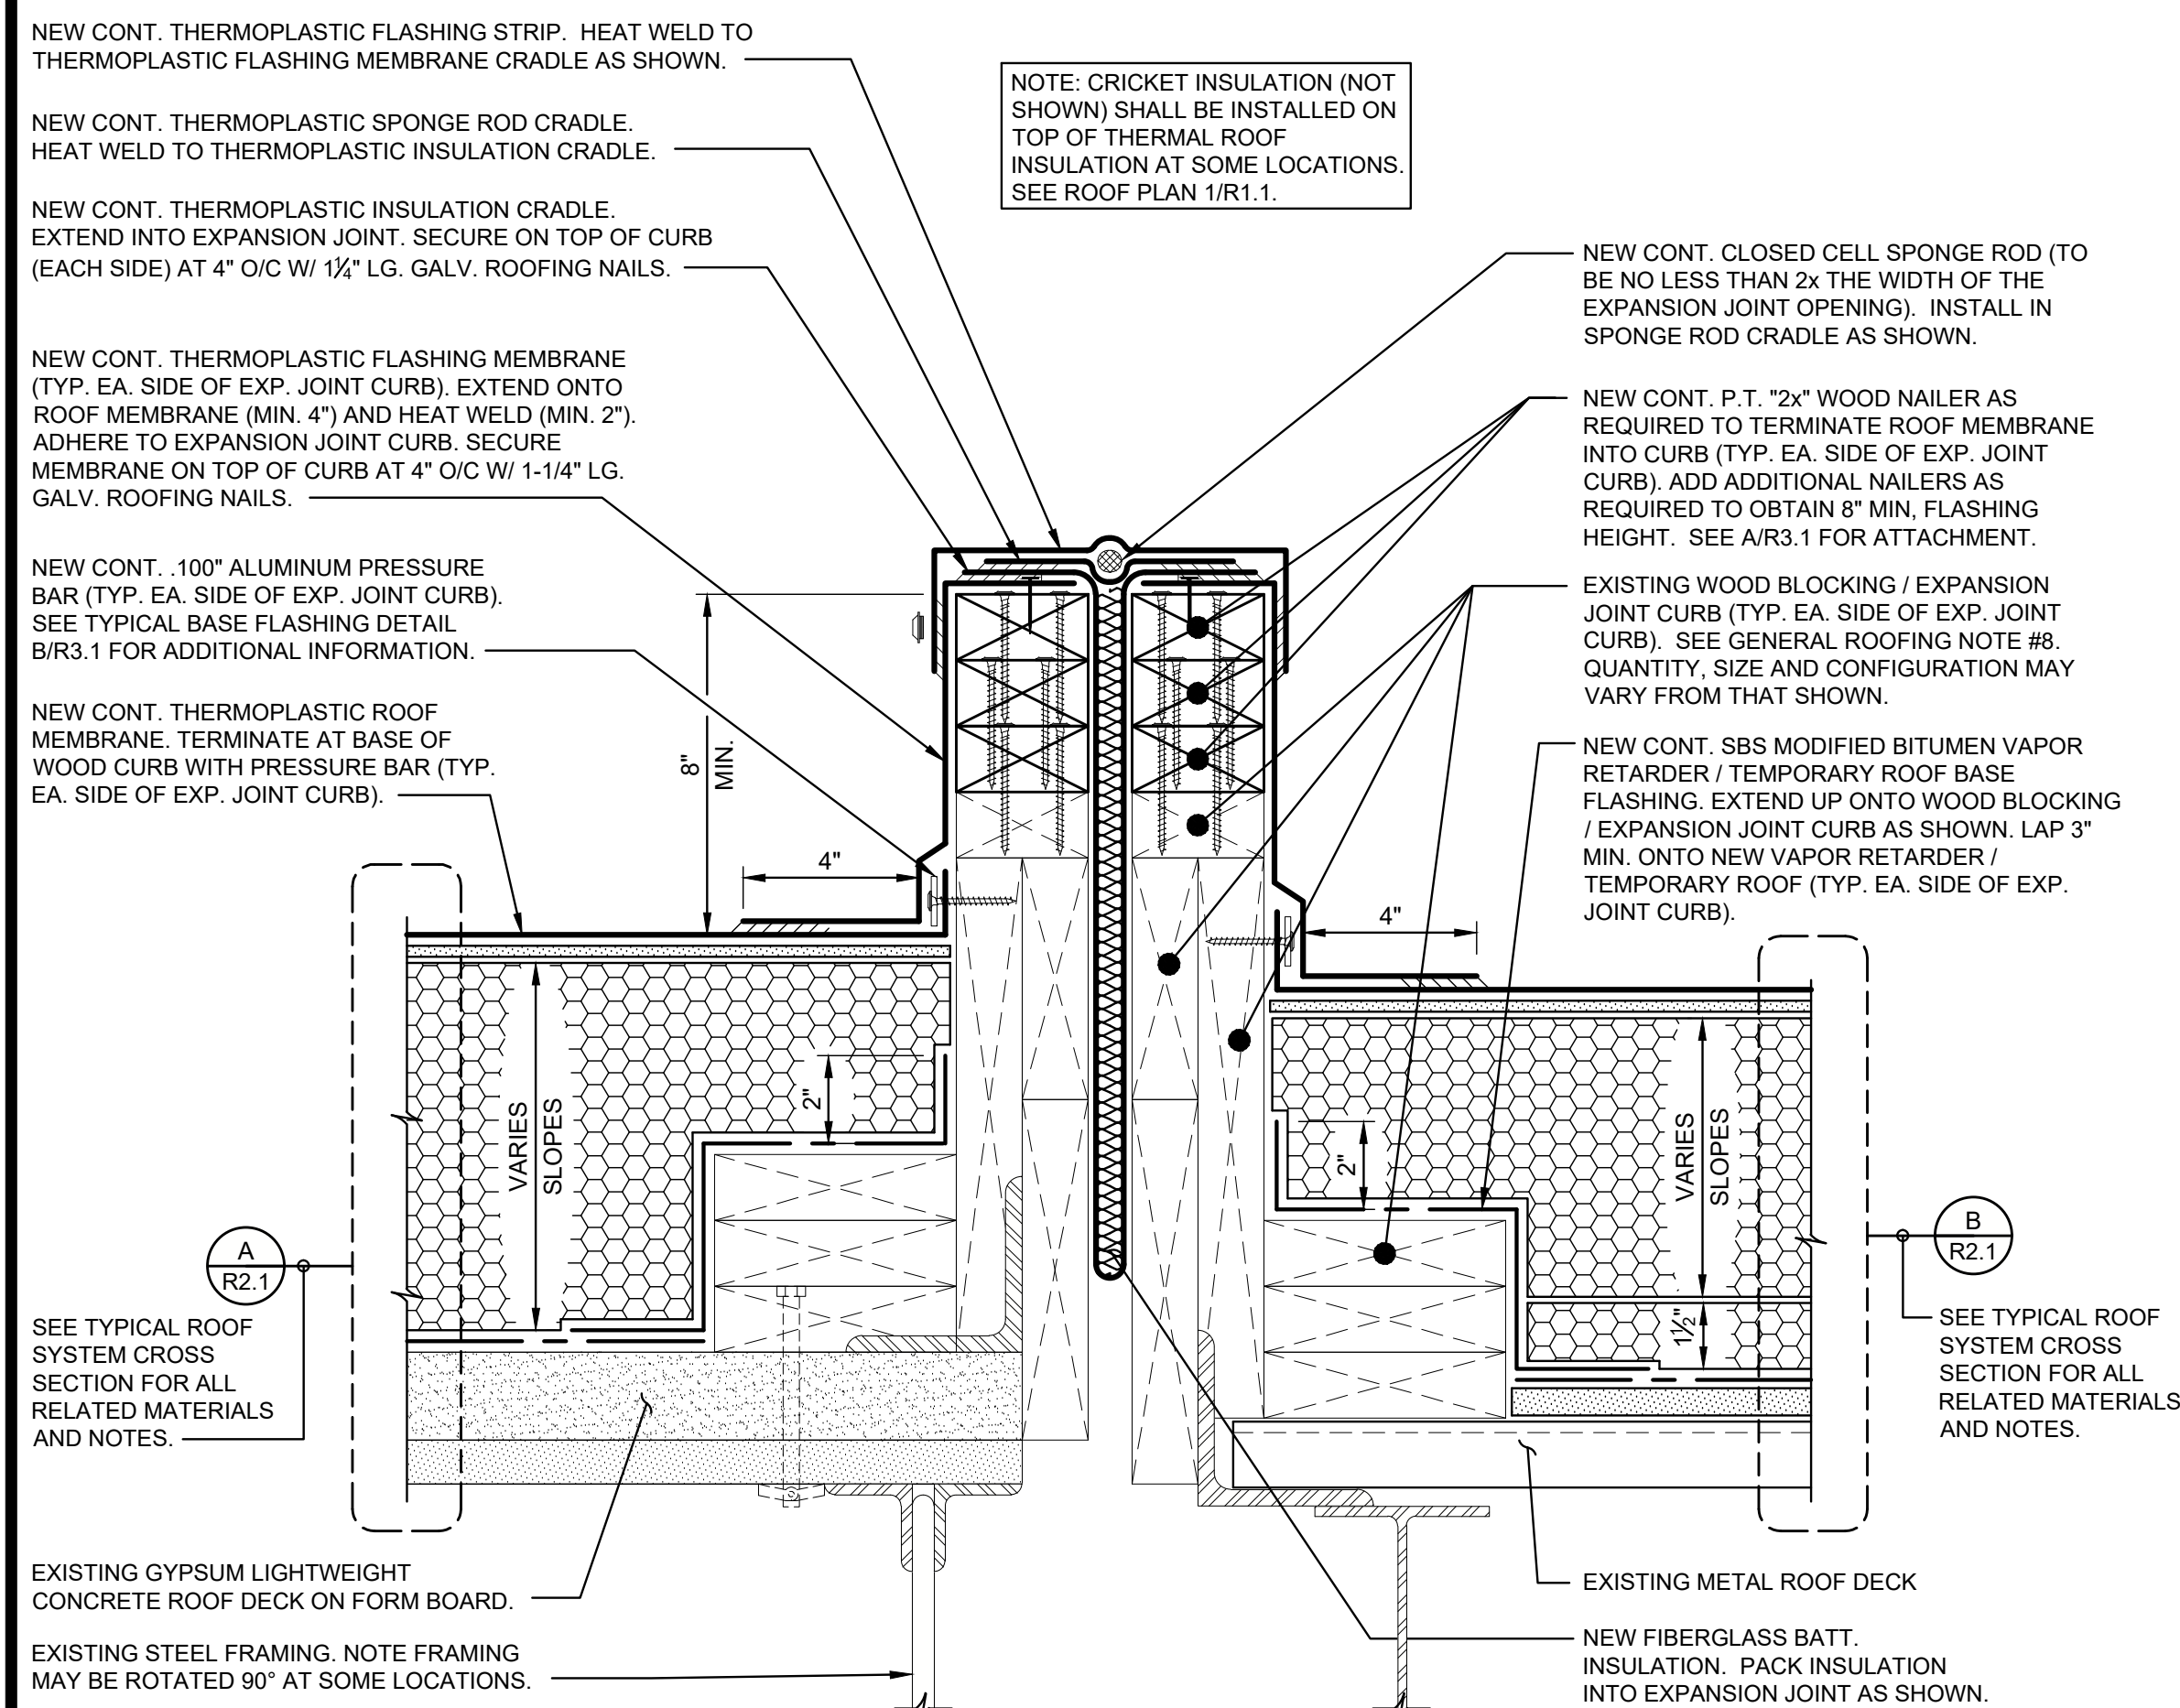

**4 SECTION - ROOF TO ROOF EXPANSION JOINT**  
R2.2  
3" = 1'-0"  
Dwg.# 220533-R6015.DWG

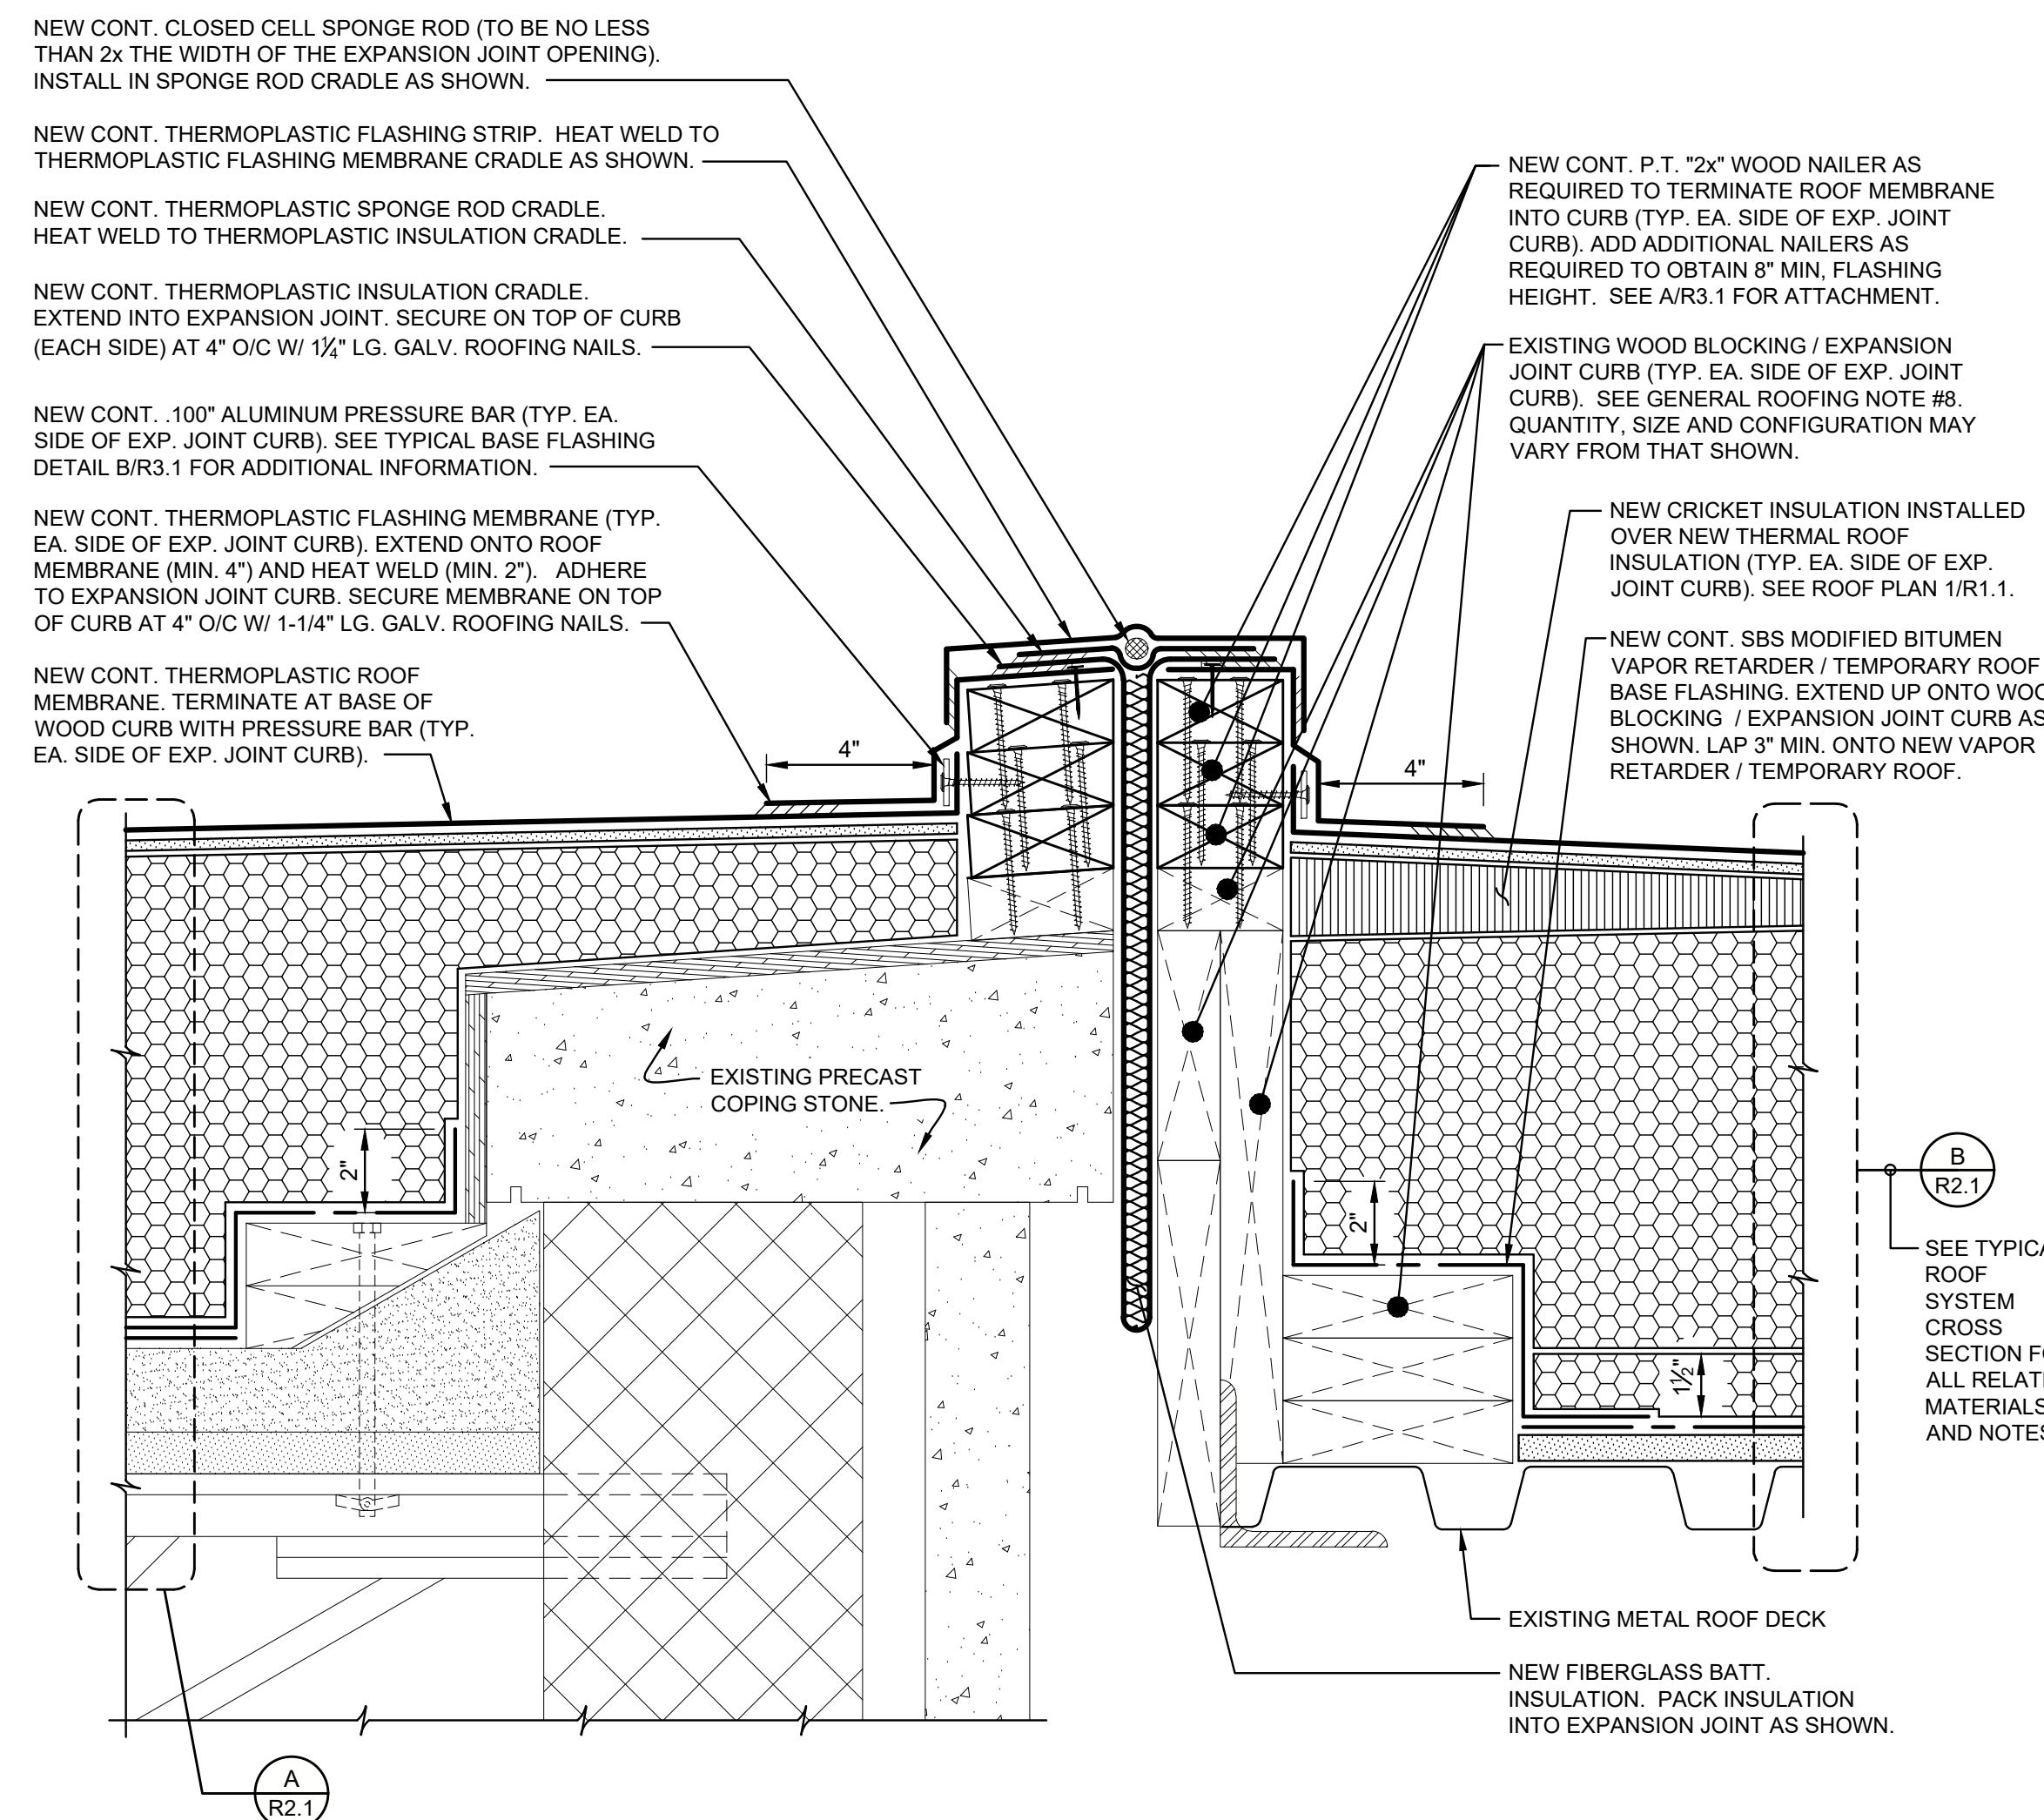


**5 SECTION - ROOF TO ROOF EXPANSION JOINT**  
R2.2  
3" = 1'-0"  
Dwg.# 220533-R6016.DWG

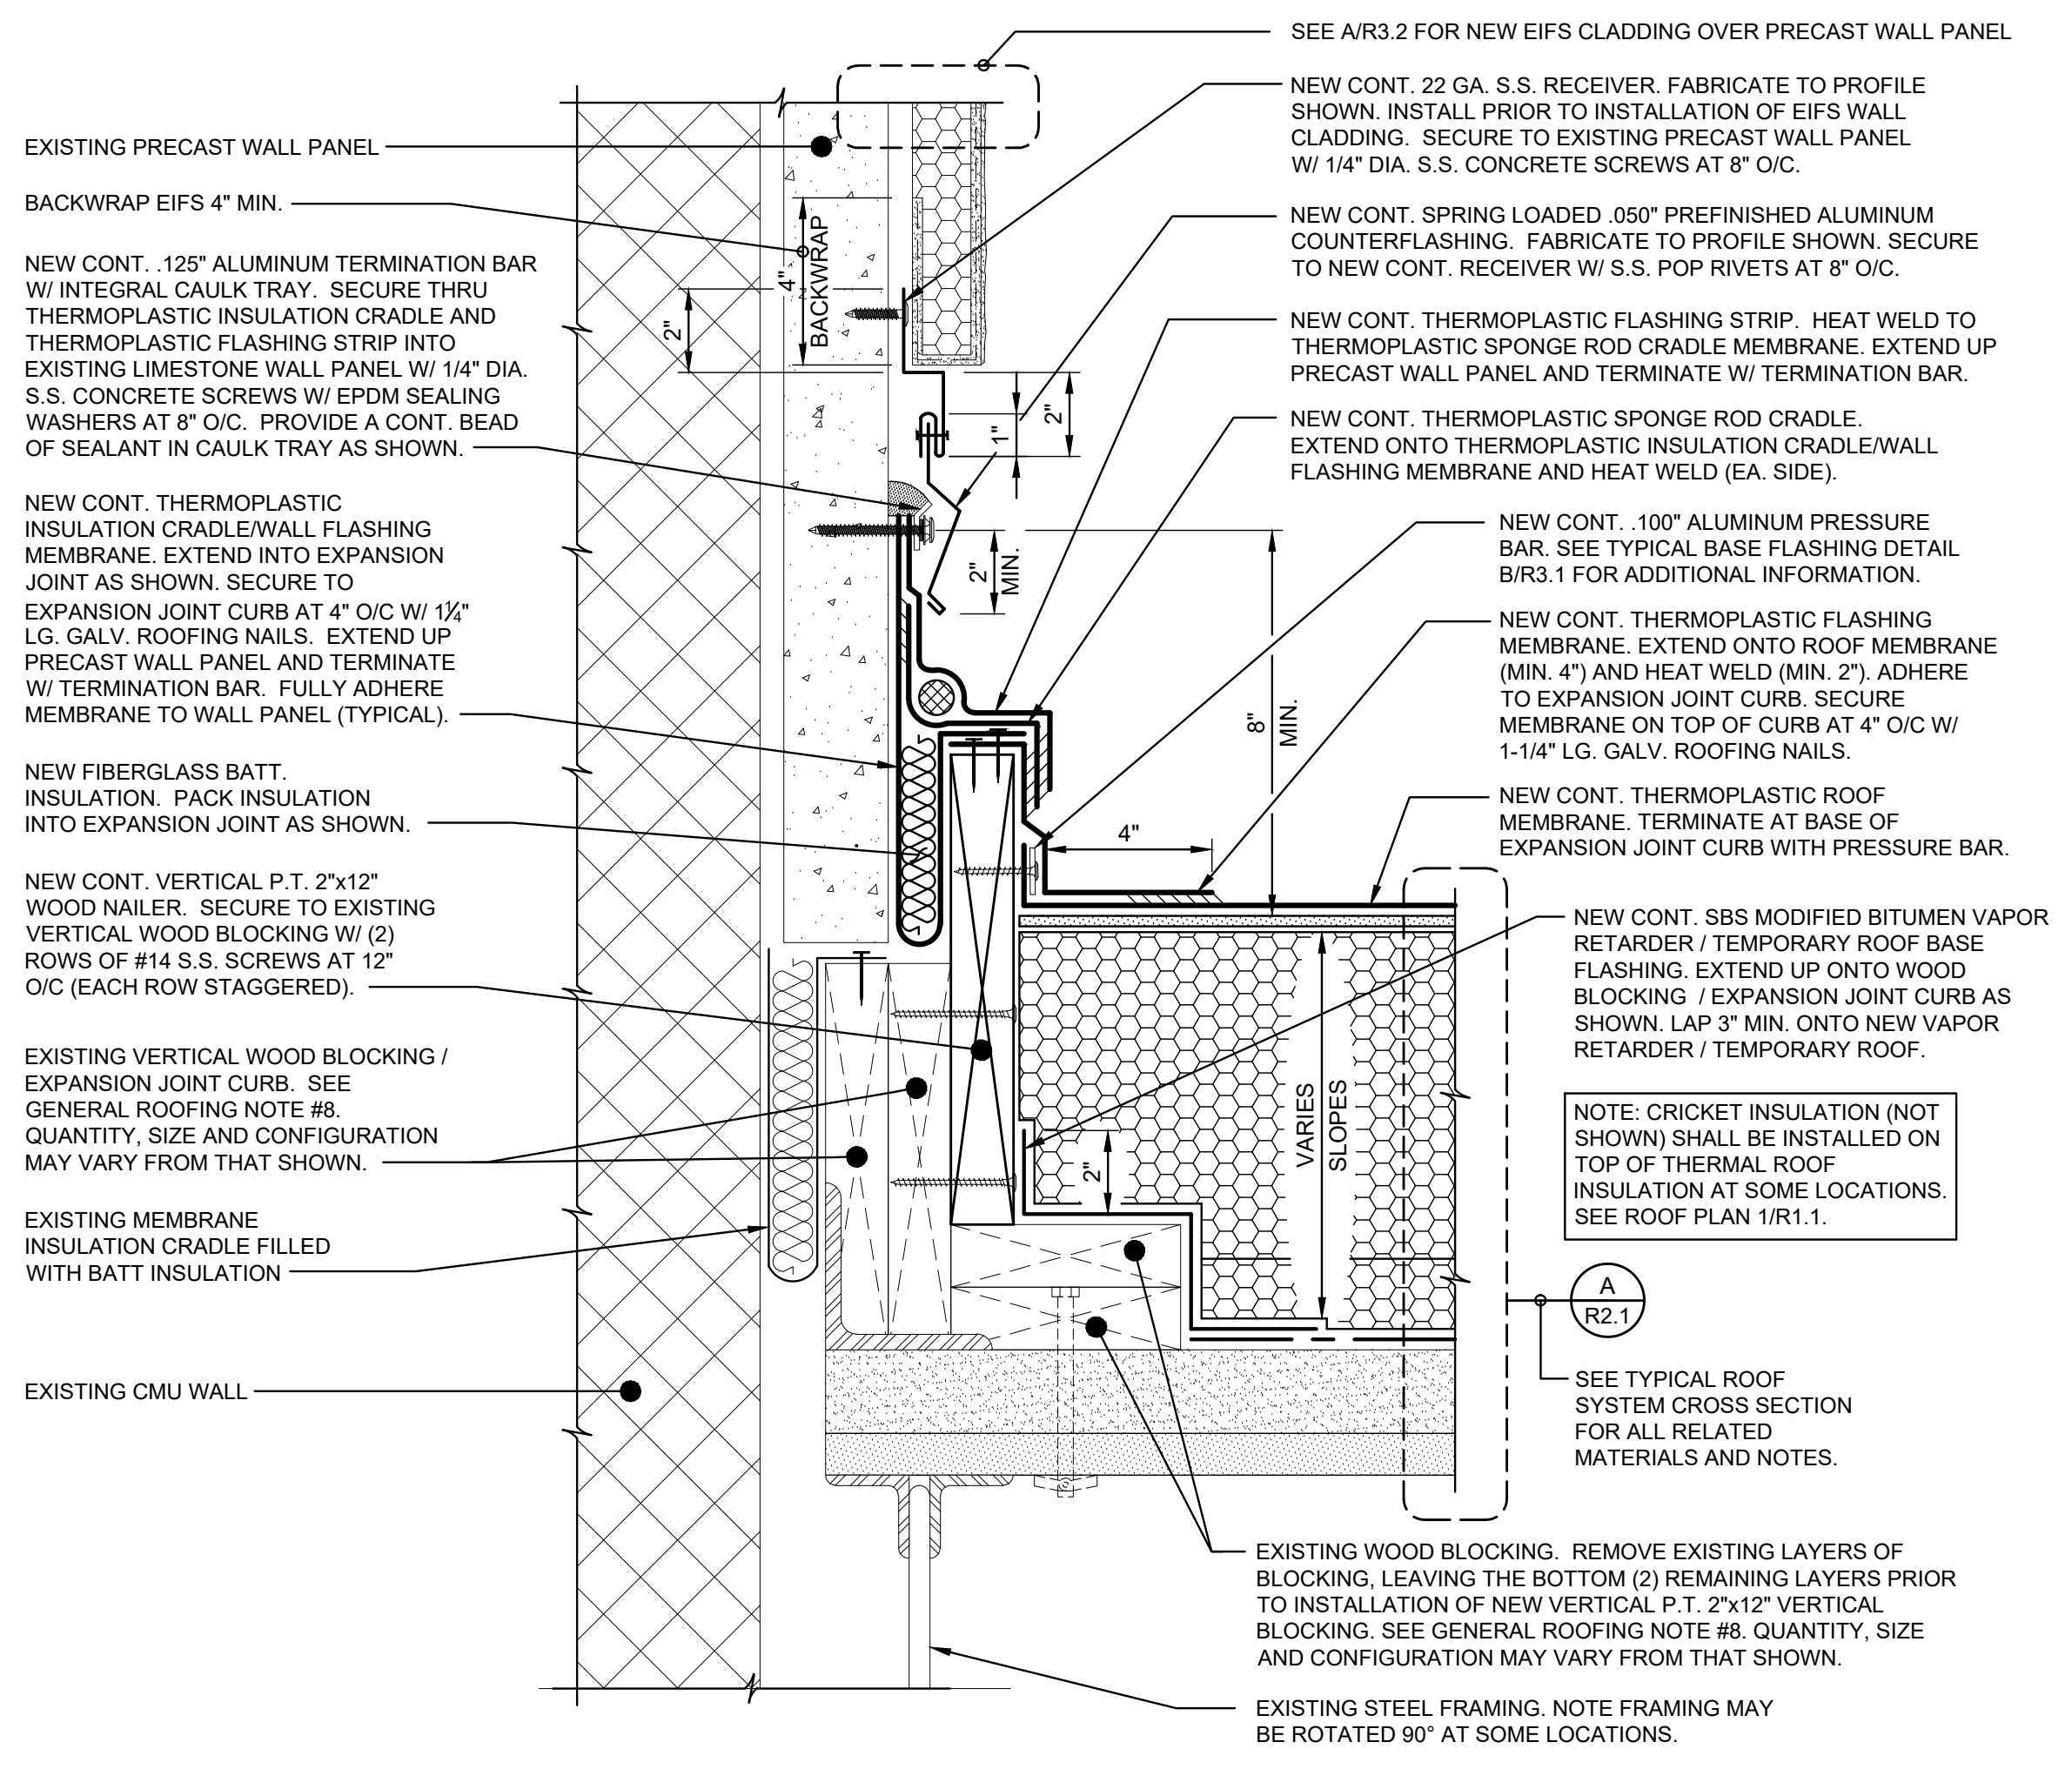

**6 SECTION - ROOF TO WALL EXPANSION JOINT**  
R2.2  
3" = 1'-0"  
Dwg.# 220533-R6006.DWG


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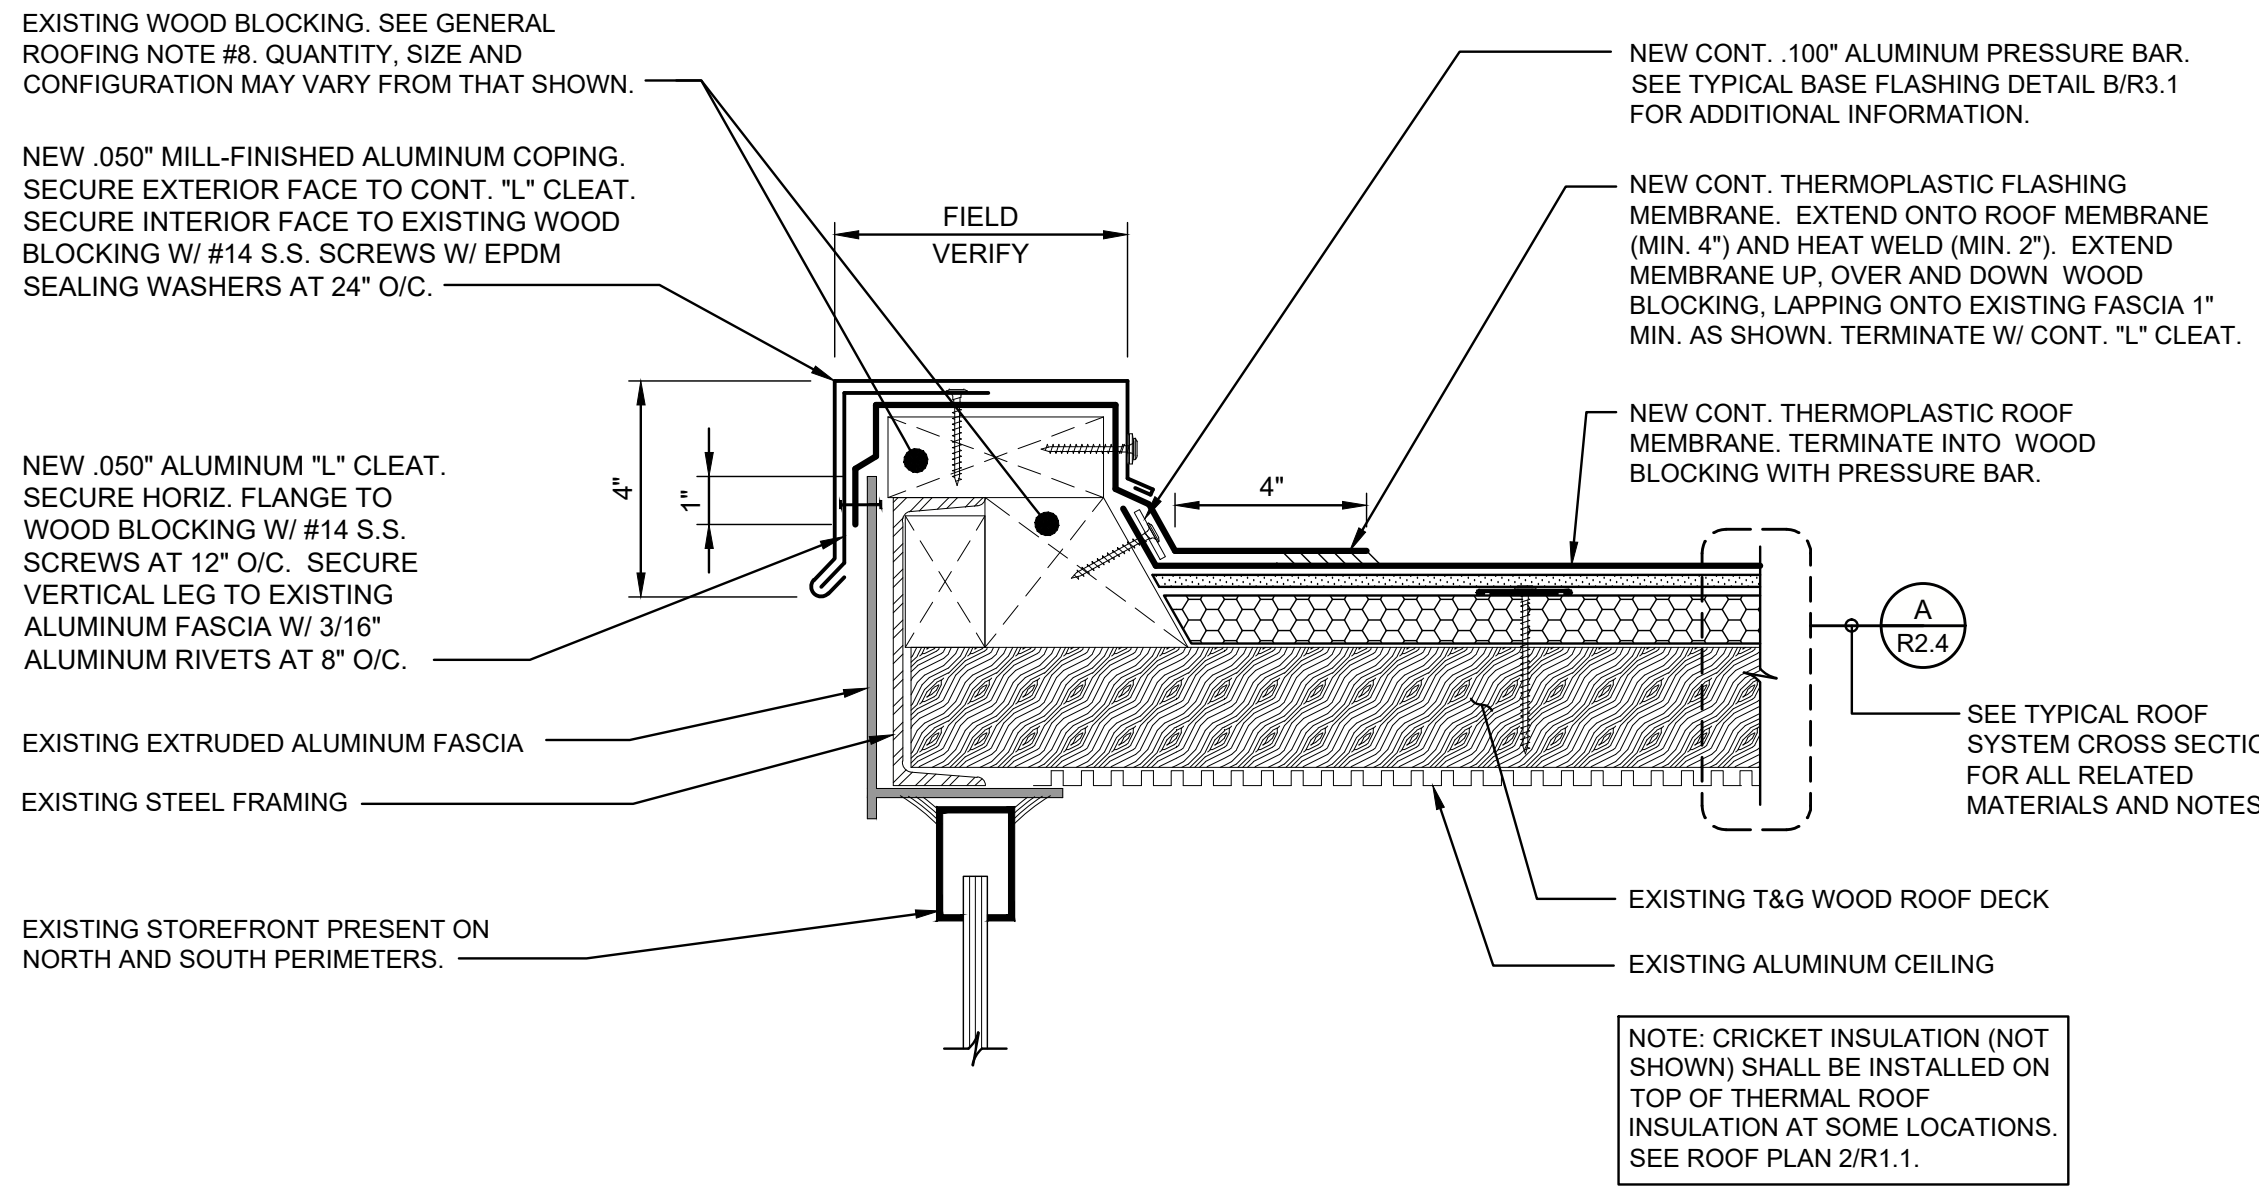
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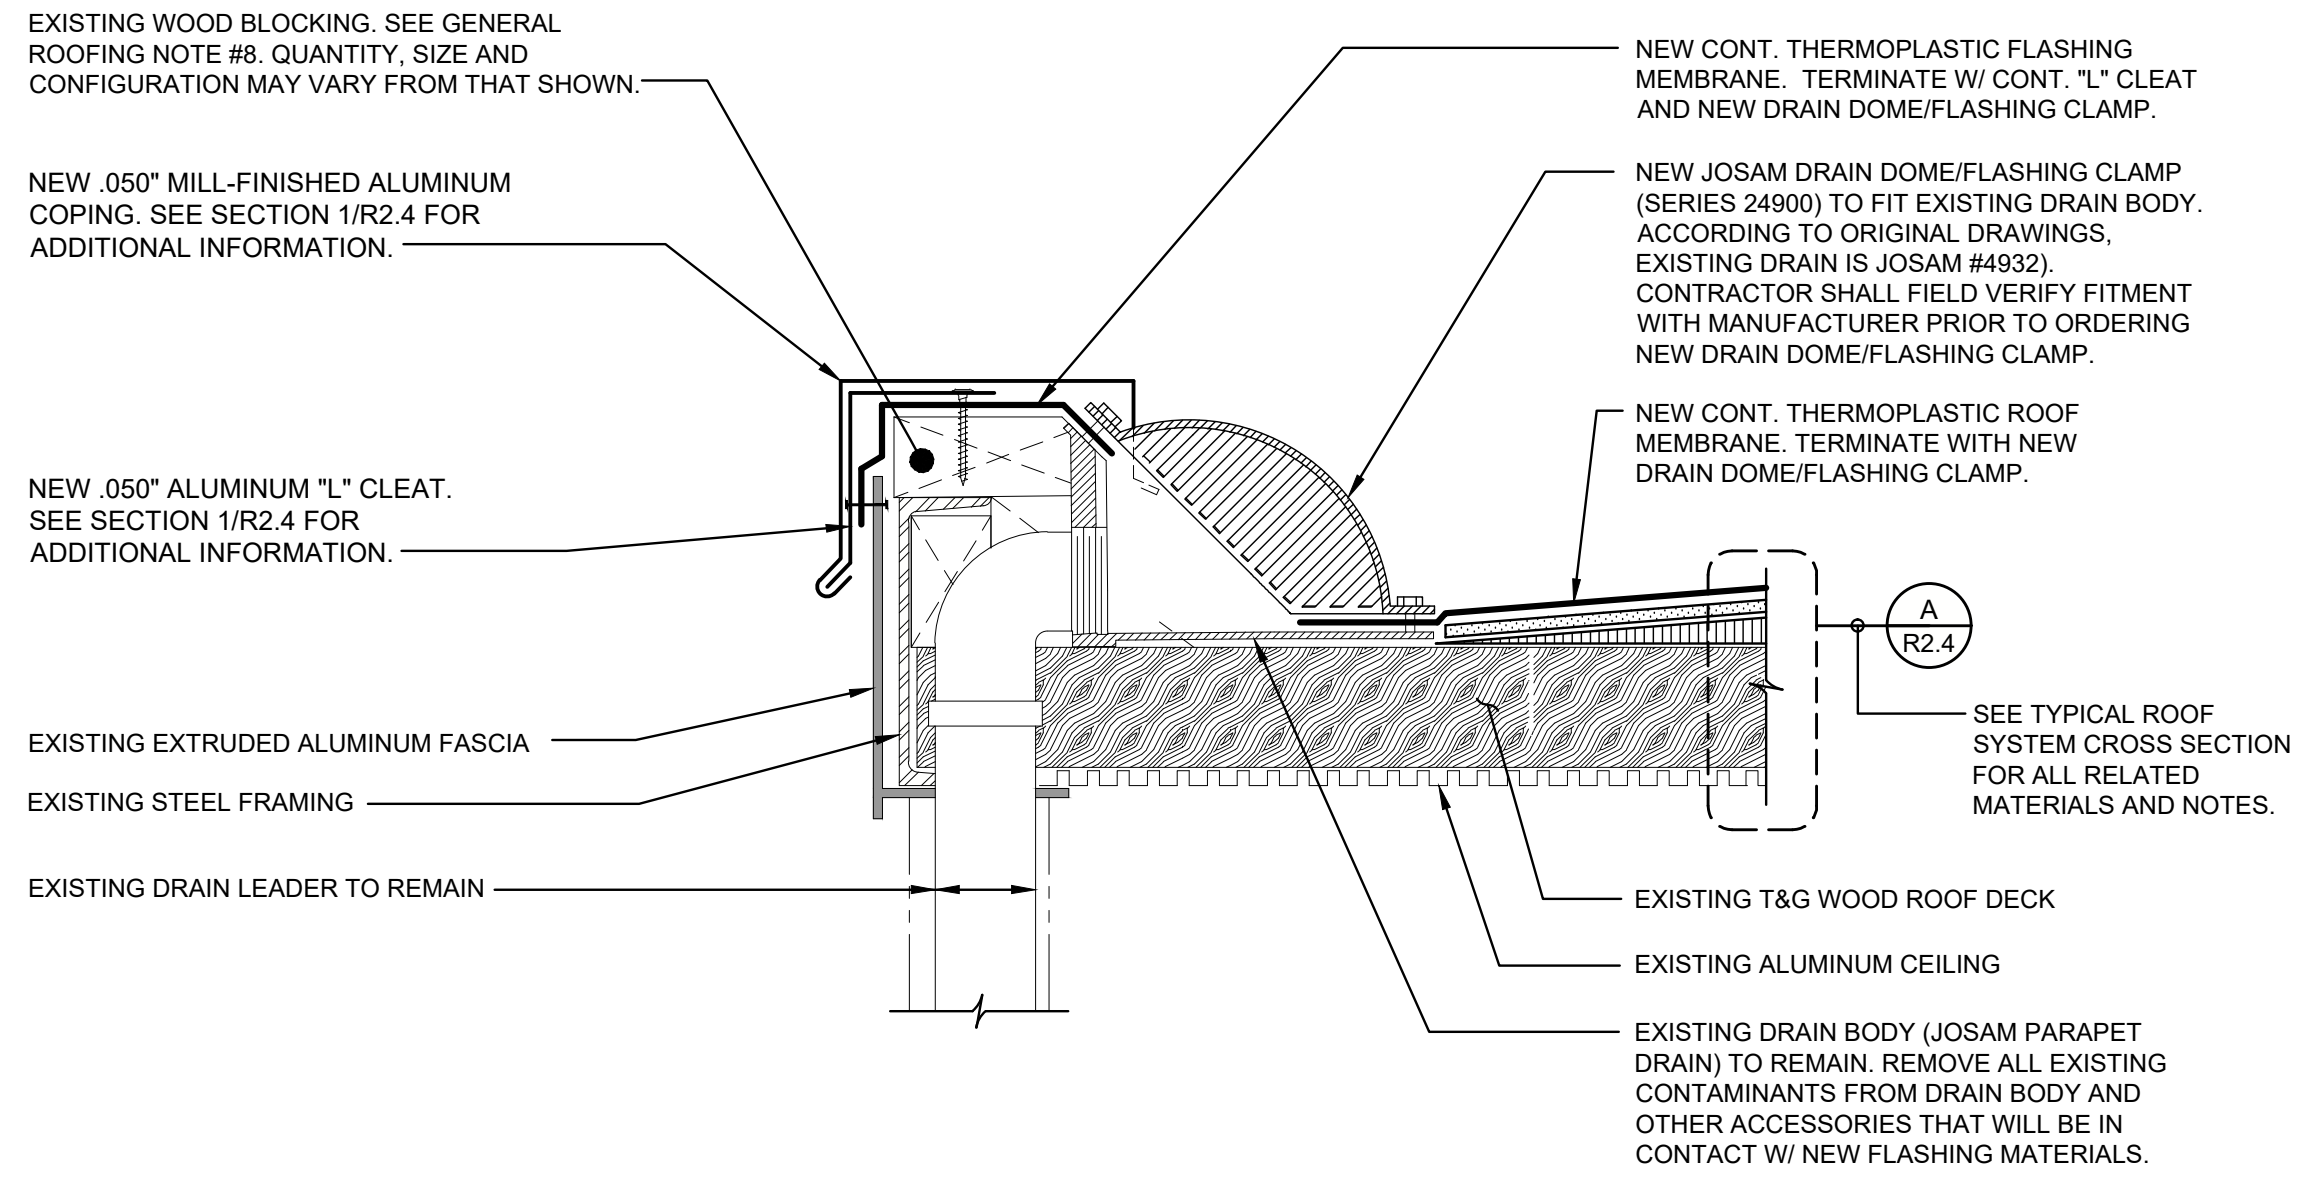
WEST ENTRANCE CANOPY ROOF

A  
R2.4  
3" = 1'-0"  
Dwg.# 220533-R6108.DWG

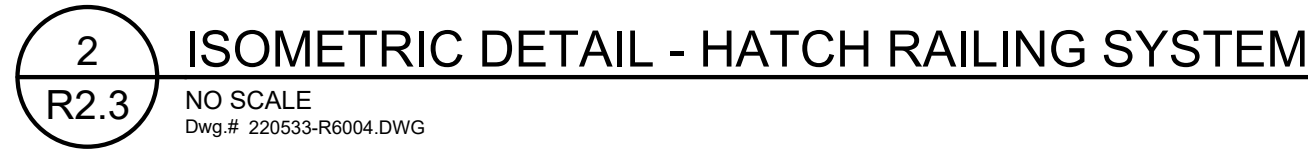


WEST ENTRANCE CANOPY ROOF

1A  
R2.4  
1  
R2.4  
3" = 1'-0"  
Dwg.# 220533-R6101.DWG

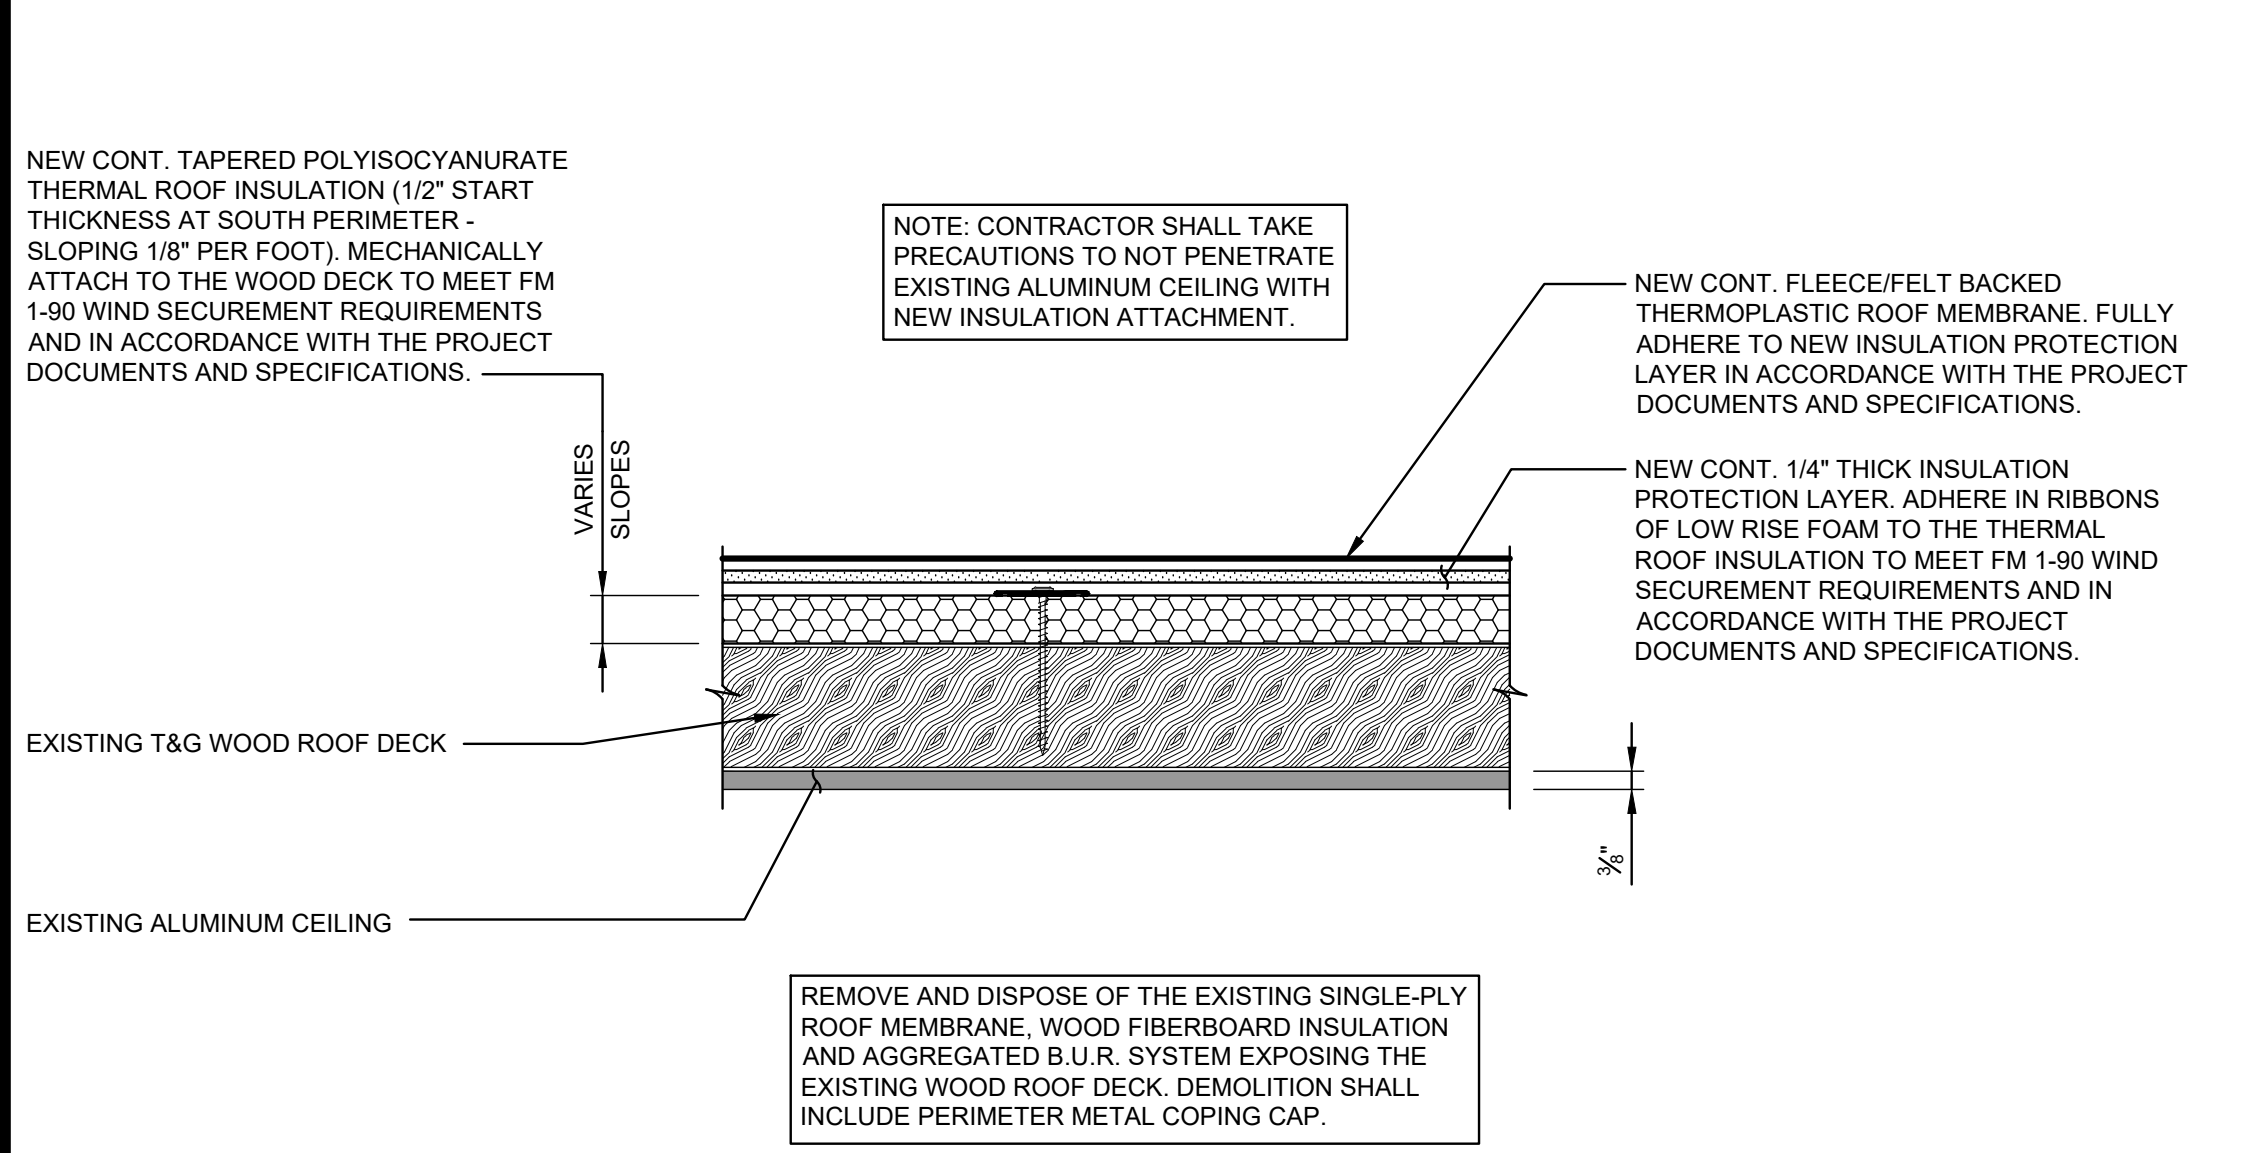


WEST ENTRANCE CANOPY ROOF

2  
R2.4  
3" = 1'-0"  
Dwg.# 220533-R6102.DWG

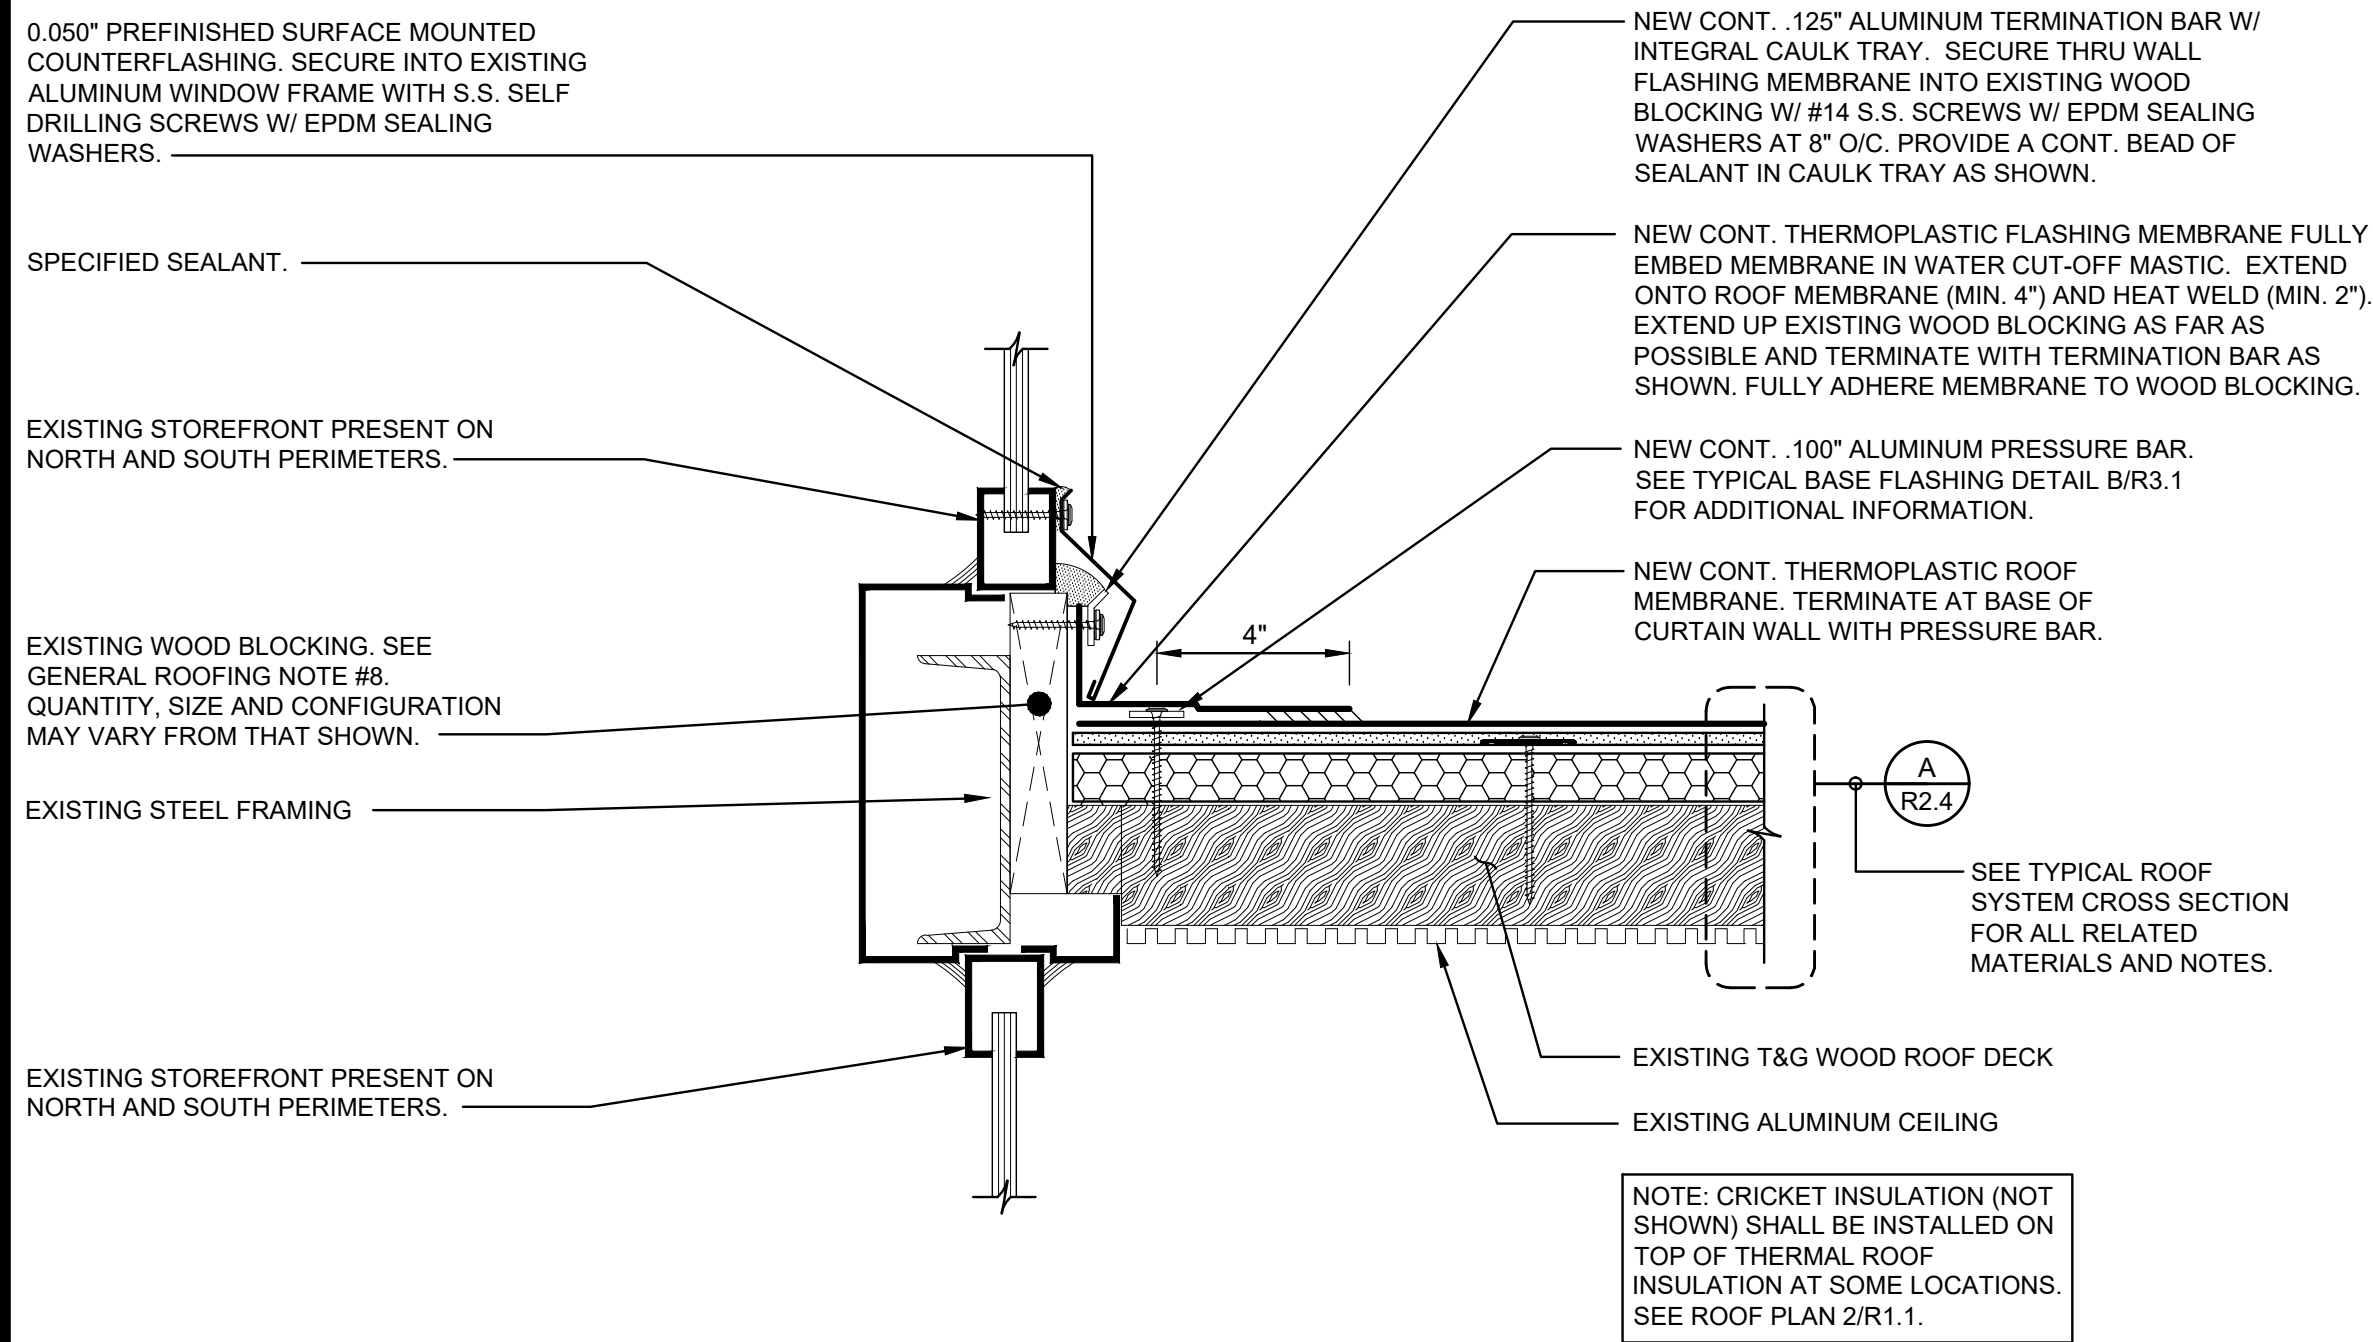

WEST ENTRANCE CANOPY ROOF

3  
R2.4  
3" = 1'-0"  
Dwg.# 220533-R6103.DWG

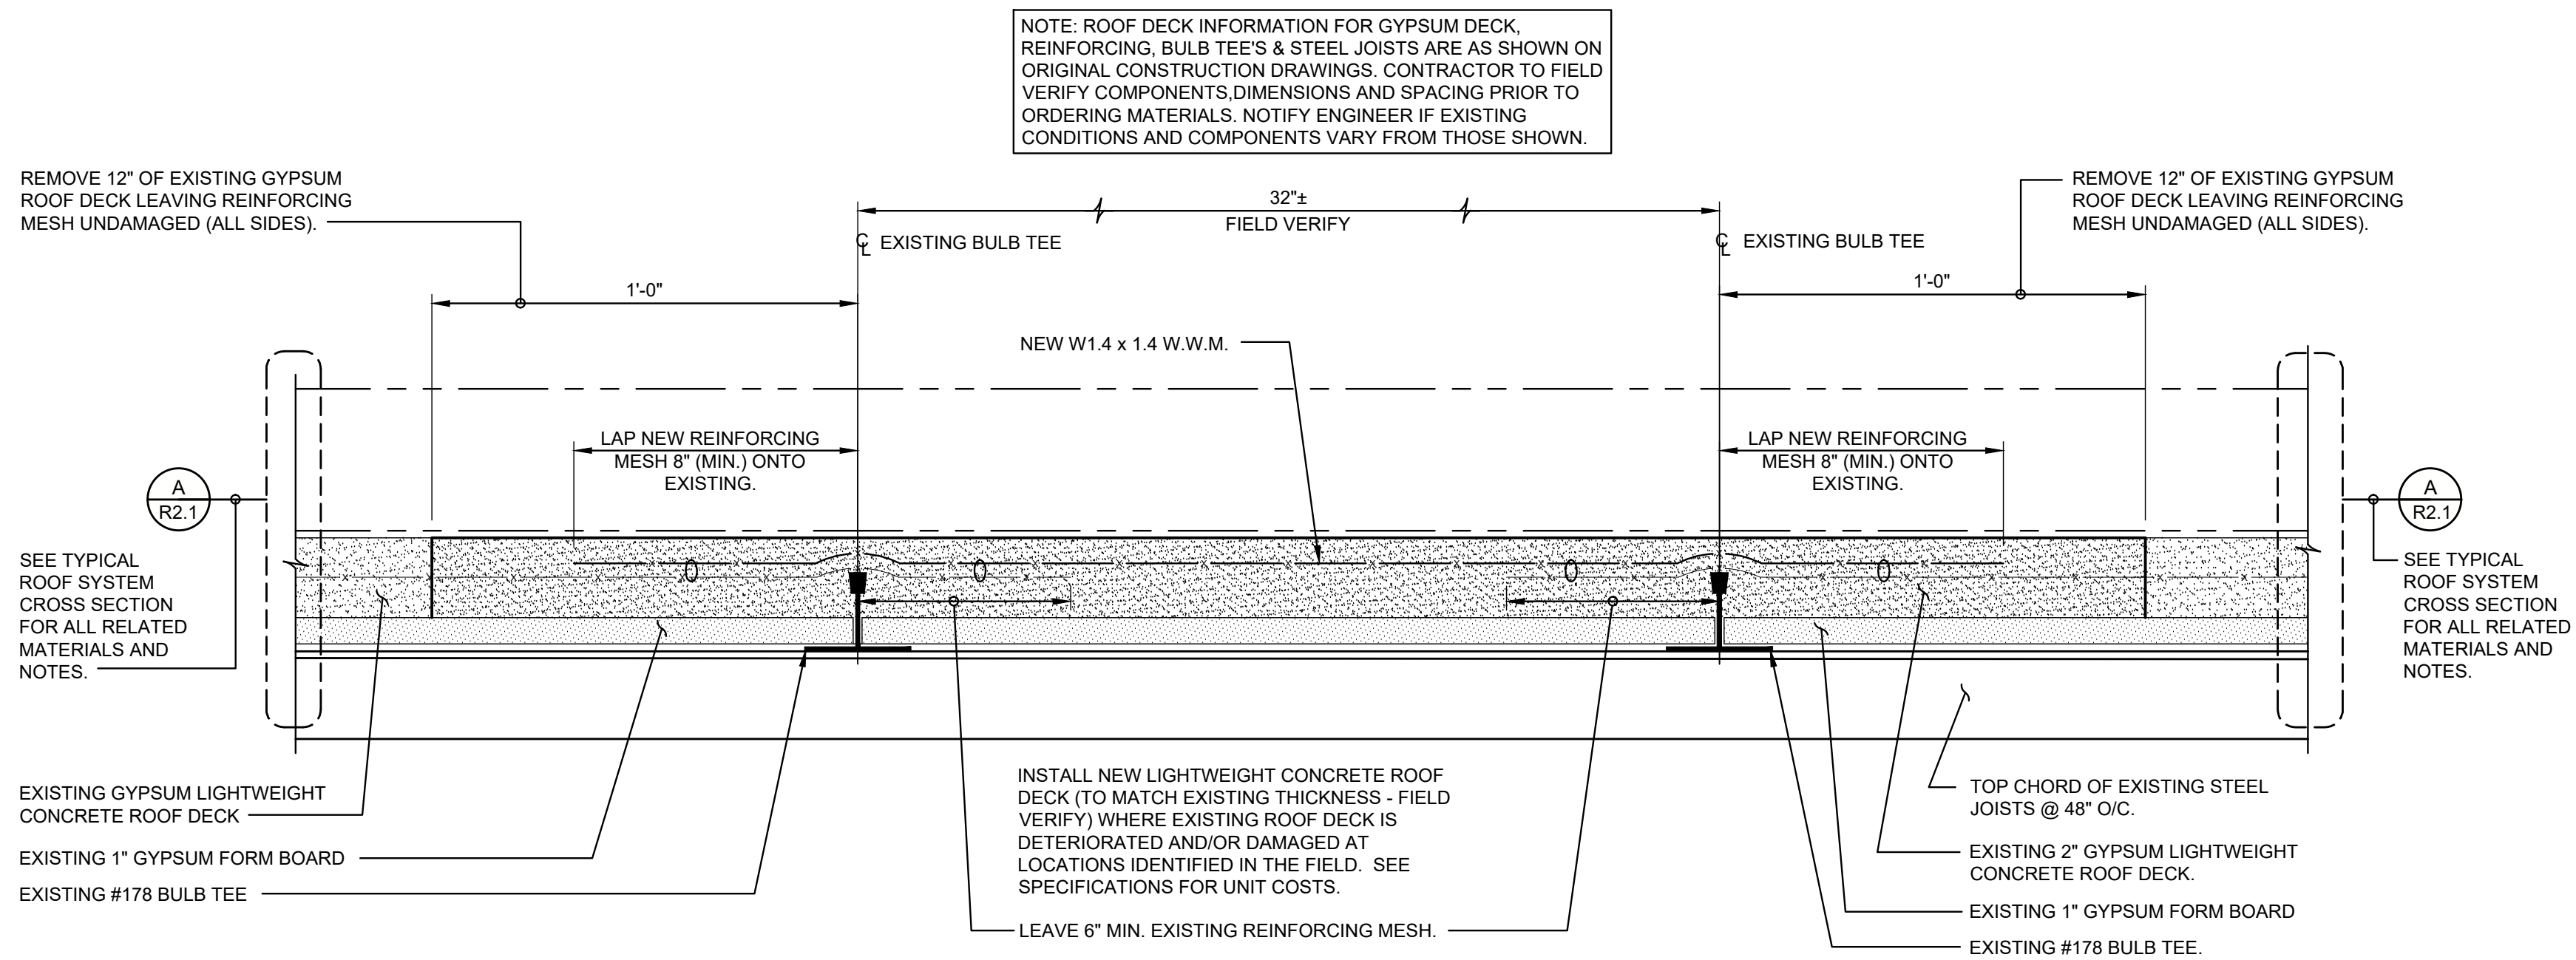

TYPICAL GYPSUM LIGHTWEIGHT ROOF DECK REPLACEMENT DETAIL

4  
R2.4  
NO SCALE  
Dwg.# 220533-R6702.DWG


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Revision	Mark	Date


BIRD BUILDING ROOF REPLACEMENT WESTERN CAROLINA UNIVERSITY WCU PR#: 2022-17 108 BIRD BUILDING LANE CULLOWHEE, NORTH CAROLINA 28723	SCO ID#: 22-25374-01A
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Designed By:	BDC
Drawn By:	JTH
Checked By:	BDC
Date:	02-14-2024






**PARTIAL ELEVATION  
PERIMETER FASCIA TO PRECAST WALL PANEL TRANSITION**  
A  
R2.5  
N.T.S.  
Dwg # 220533-R6050.DWG

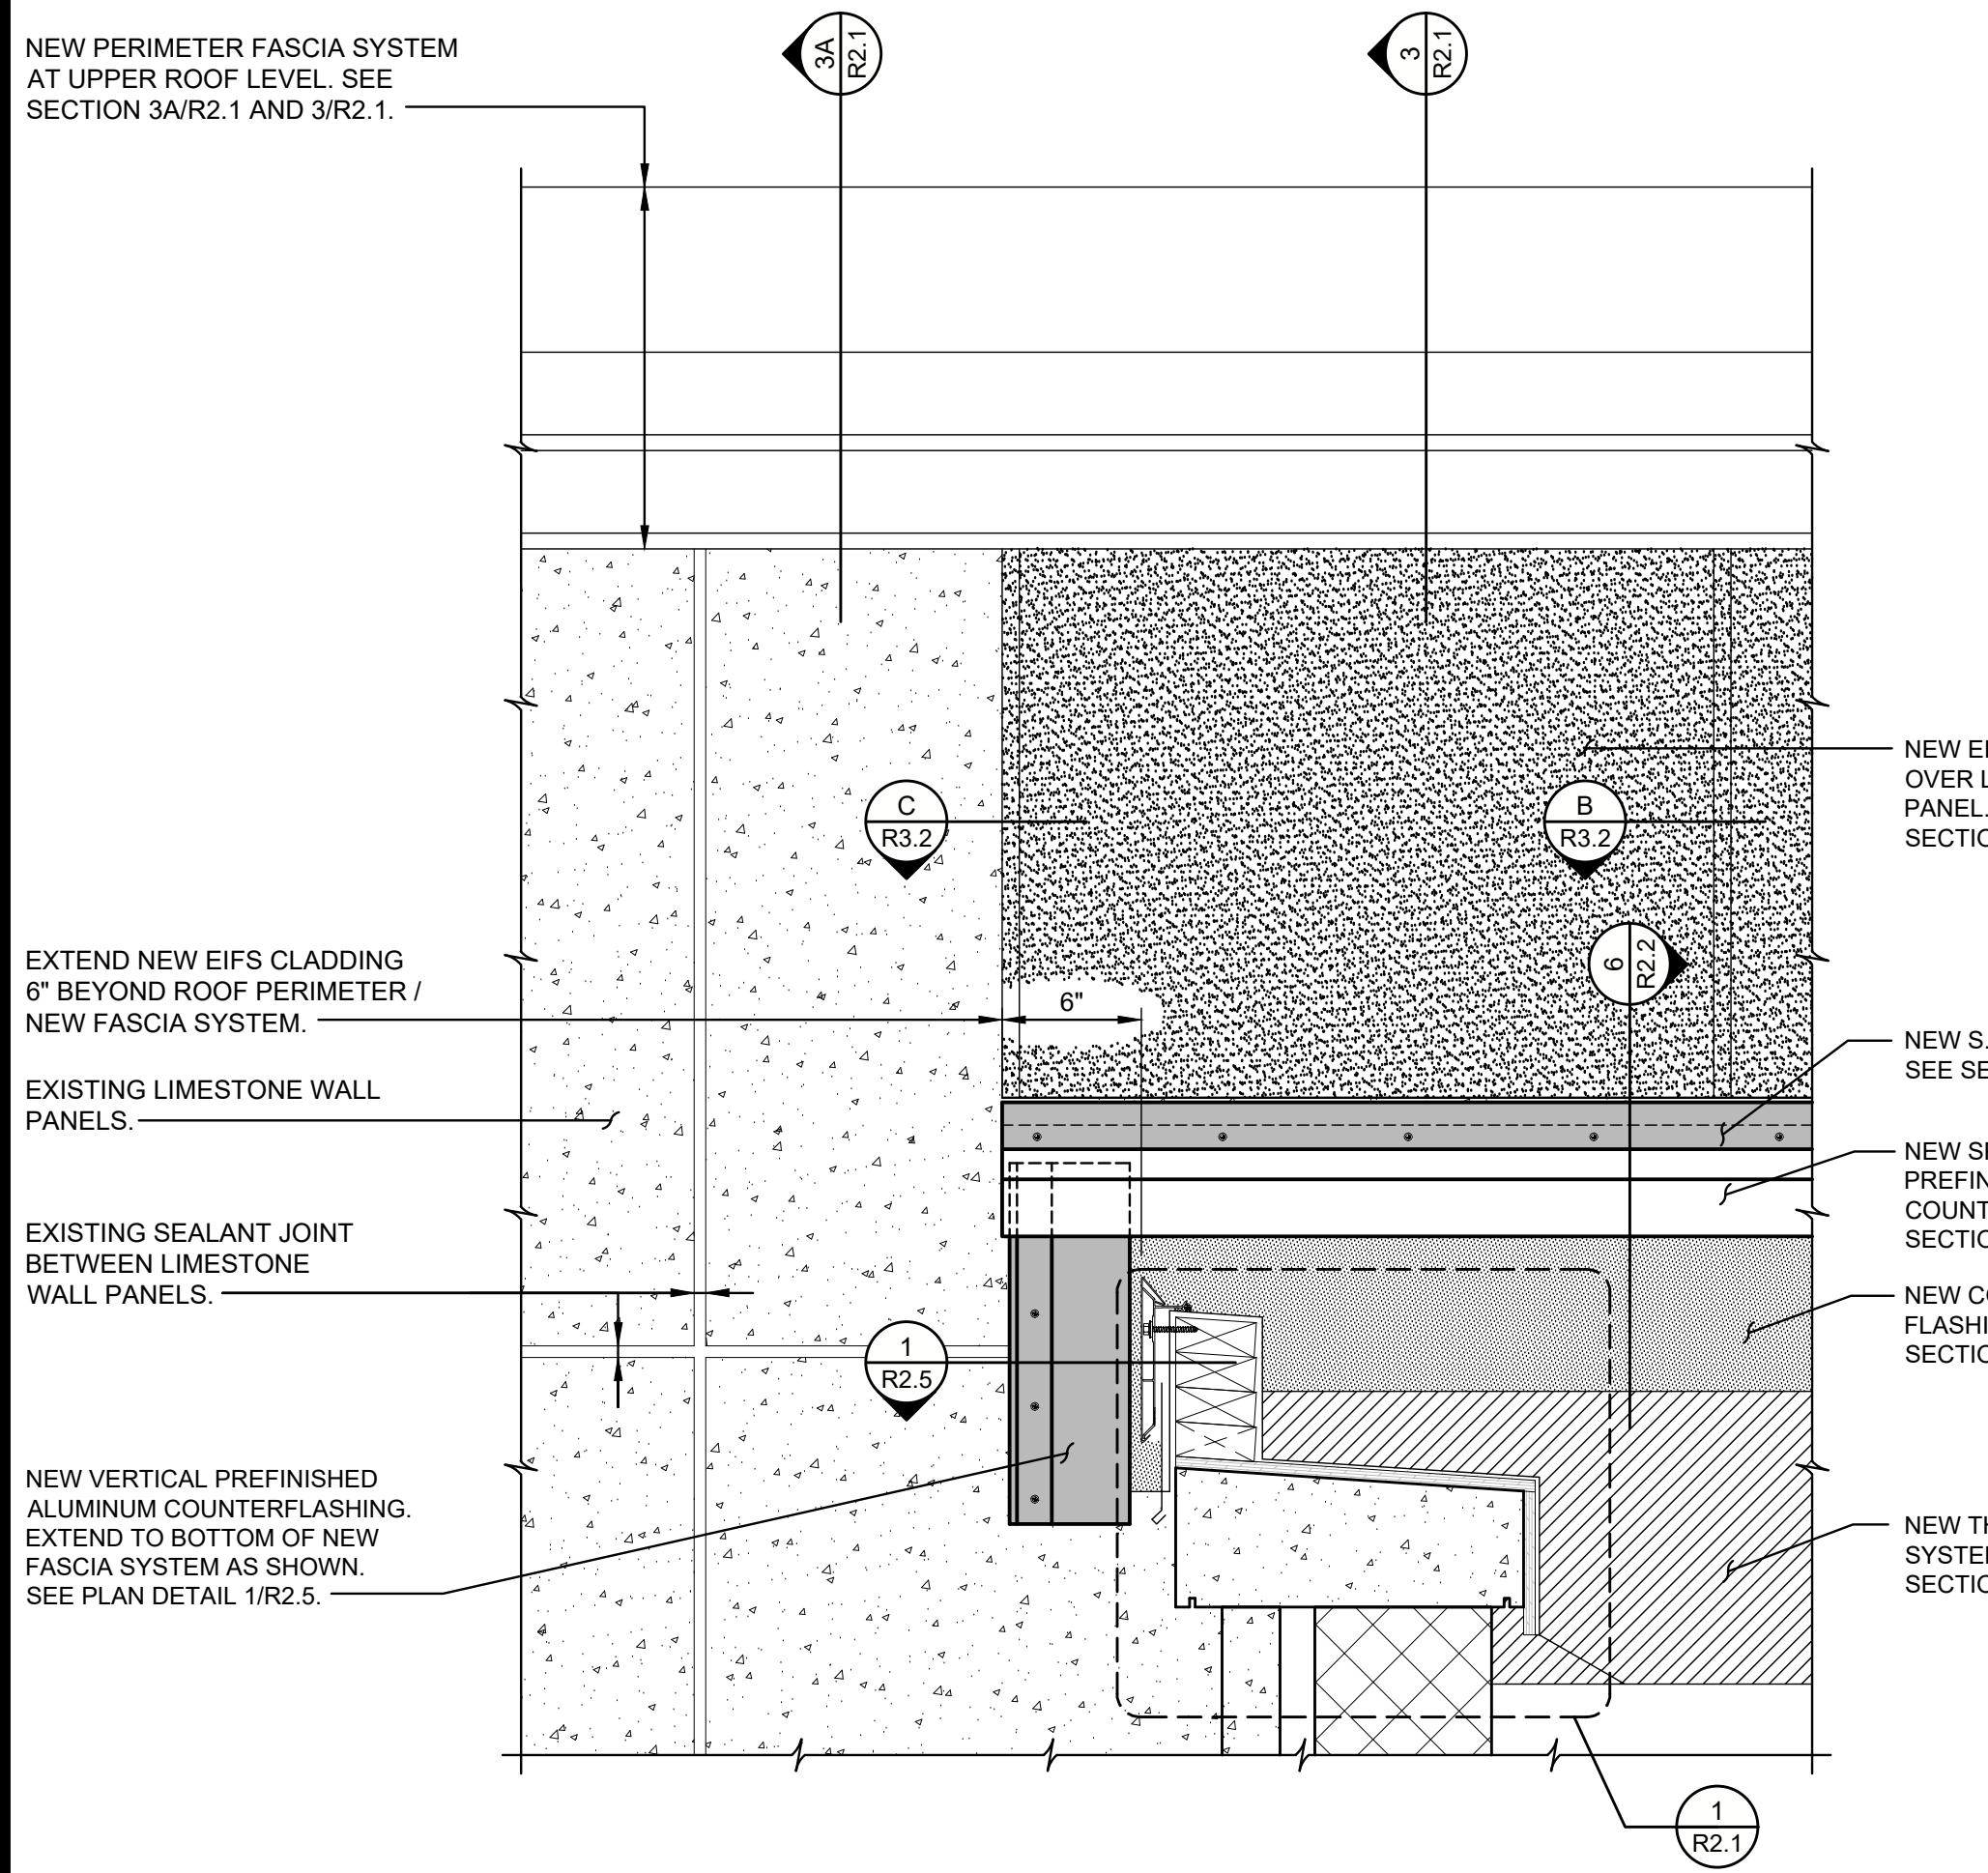

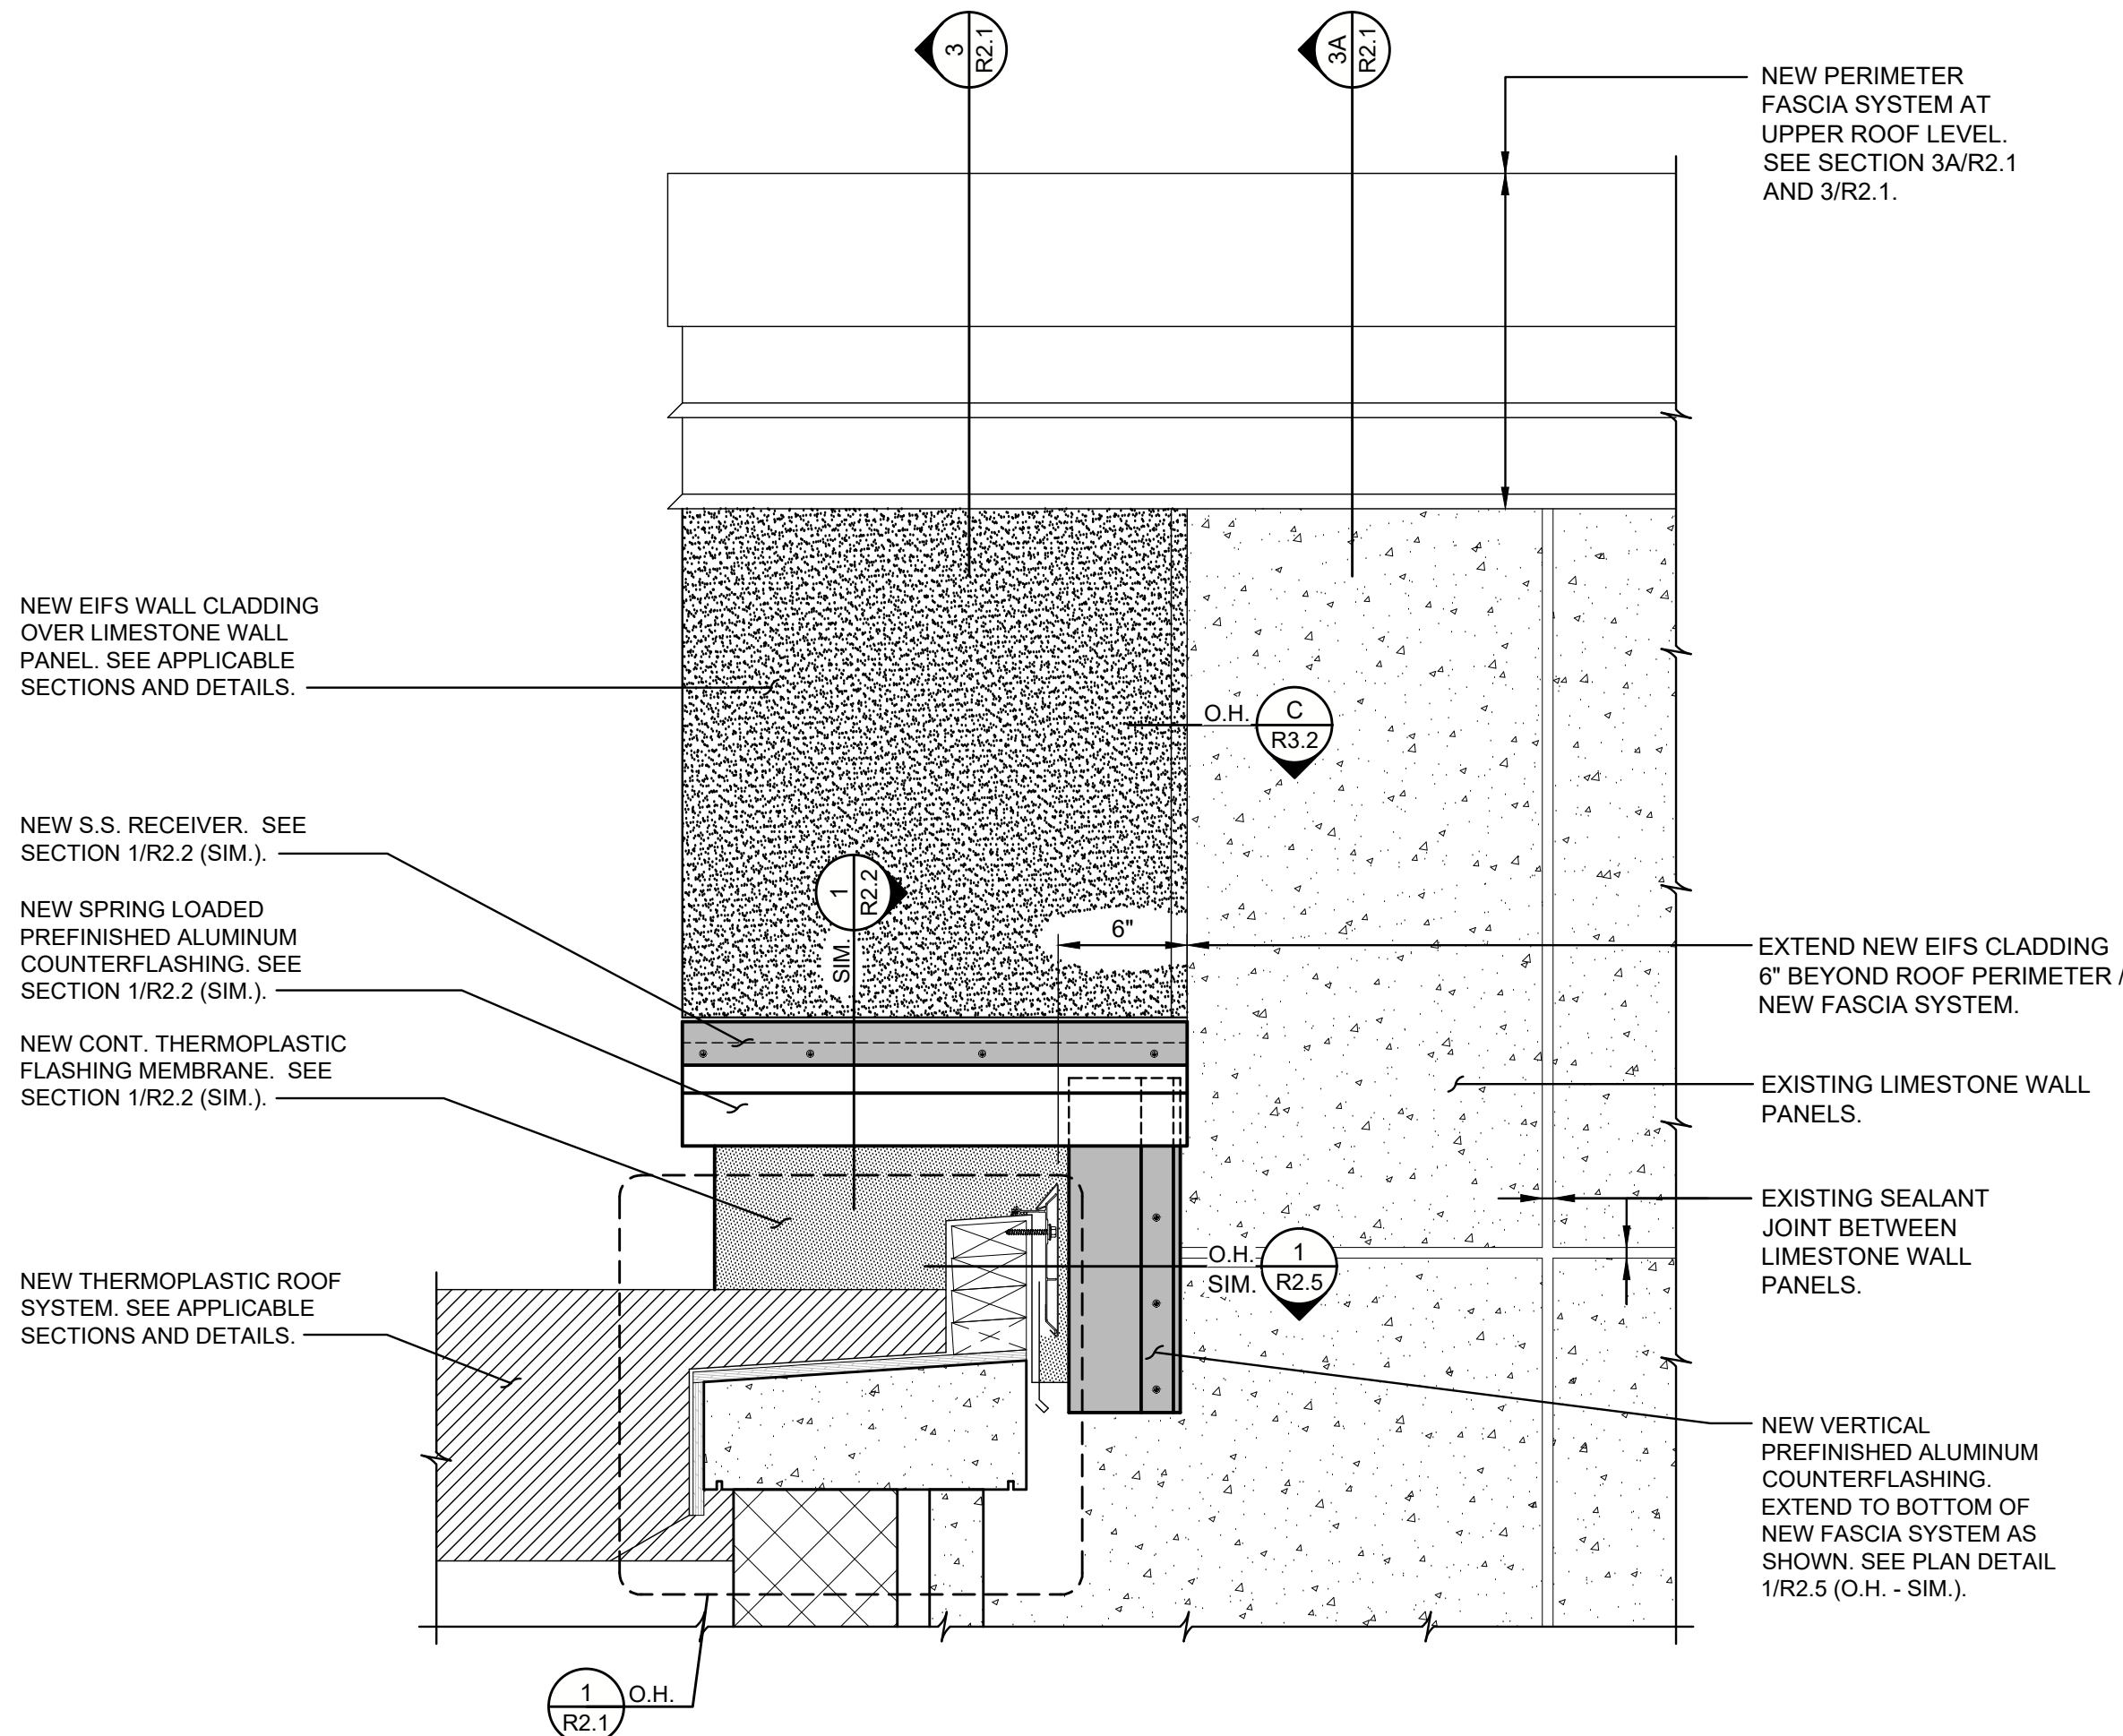**PARTIAL ELEVATION  
PERIMETER FASCIA TO PRECAST WALL PANEL TRANSITION**  
B  
R2.5  
N.T.S.  
Dwg # 220533-R6050.DWG

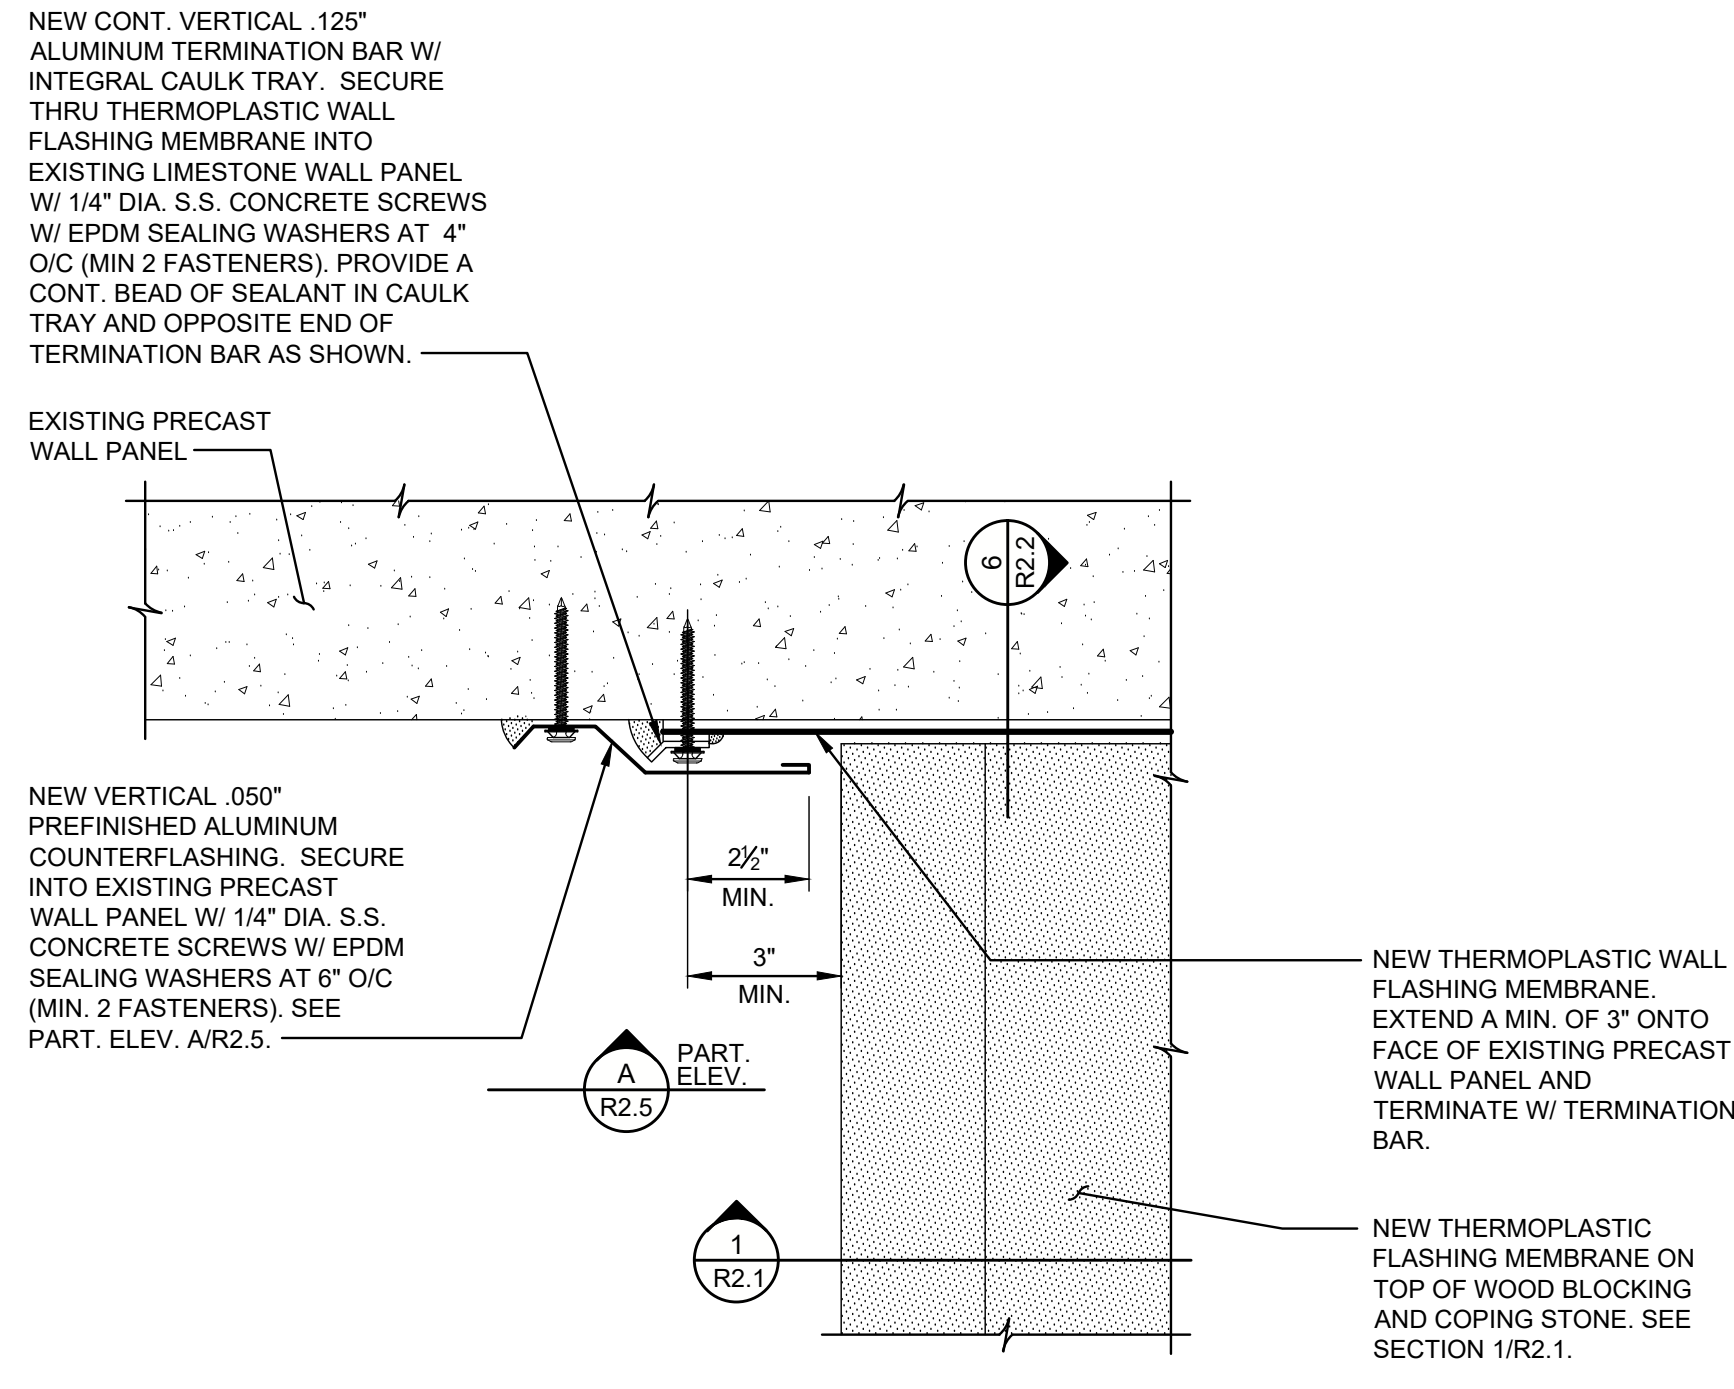

**PLAN DETAIL - PERIMETER FASCIA  
TO PRECAST WALL PANEL TRANSITION**  
1  
R2.5  
3" = 1'-0"  
Dwg # 220533-R6051.DWG

NOTE: INFORMATION SHOWN IN DETAILS FOR FRAMING, DECKING AND SUPPORTS IS FOR ILLUSTRATION ONLY AND MAY NOT REFLECT ACTUAL CONDITIONS. ADJUSTMENTS IN THE WORK MAY BE NECESSARY TO COMPENSATE FOR VARIATIONS IN ACTUAL FIELD CONDITIONS. CONTRACTOR SHALL NOTIFY THE ENGINEER IF CONDITIONS VARY FROM THOSE SHOWN.

CONSTRUCTION DOCUMENTS:

BIRD BUILDING ROOF REPLACEMENT  
WESTERN CAROLINA UNIVERSITY  
WCU PR#: 2022-17 SCO ID#: 22-25374-01A  
108 BIRD BUILDING LANE  
CULLOWHEE, NORTH CAROLINA 28723

ROOF SECTIONS & DETAILS

Designed By: BDC  
Drawn By: JTH  
Checked By: BDC  
Date: 02-14-2024

R2.5

**SKA**  
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Project Number: 220533  
Name: 220533-R6050  
Project: 2/16/2024 7:46 AM









