


REID GYMNASIUM REID 119 TOILET ROOM RENOVATION

194 MEMORIAL DR. CULLOWHEE, N.C. 28723

SCO ID # 23-26576-01A

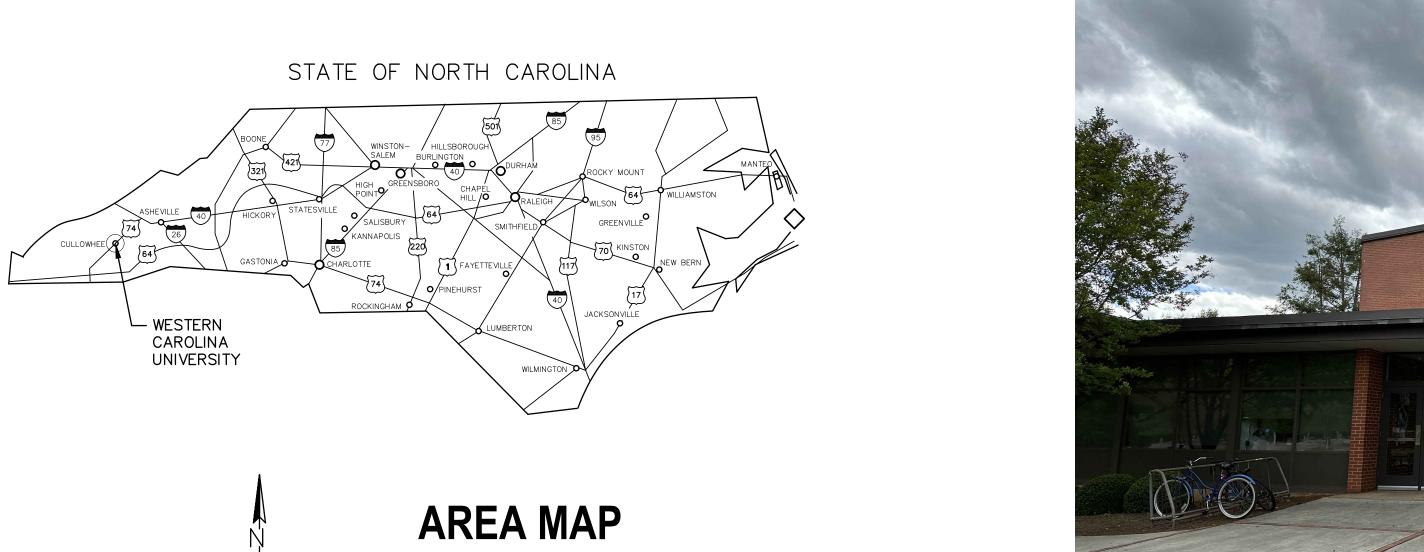

ARCHITECTURAL
JAVIER TORRES, AIA
UNIVERSITY ARCHITECT
WCU FACILITIES MANAGEMENT
3476 OLD CULLOWHEE ROAD
CULLOWHEE, NC 28723
828-227-7198

MECHANICAL / PLUMBING ENGINEER
SUD ASSOCIATES, P.A. CONSULTING ENGINEERS
90 SOUTHSIDE AVENUE, SUITE 350
ASHEVILLE, NC 28801
828-255-4691

ELECTRICAL ENGINEER
BURDETTE ENGINEERING, INC.
200 REGENT PARK COURT
GREENVILLE, SC 29607
864-297-8717



INDEX OF DRAWINGS

| G001 G010 | COVER SHEET / INDEX OF DRAWINGS BUILDING CODE SUMMARY - APPENDIX B |
|--------------|--|
| A100 | DEMOLITION PLAN, NEW FLOOR PLAN, REFLECTED CEILING PLA INTERIOR ELEVATIONS, DETAILS |
| M101 | MECHANICAL - DEMOLITION & NEW PLAN |
| P100 | PLUMBING - LEGEND, NOTES, SCHEDULE |
| P101 | PLUMBING - DEMOLITION & NEW PLAN |
| E100 | ELECTRICAL - DEMOLITION, NEW PLAN & SCHEDULE |




CAMPUS MAP

WESTERN CAROLINA UNIVERSITY
CULLOWHEE, NORTH CAROLINA


REID GYMNASIUM
REID 119 TOILET ROOM RENOVATION
SCO ID #: 23-26576-01A

WCU" #: 2023-008

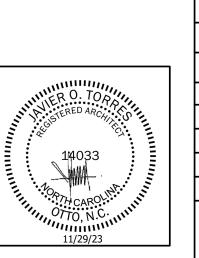

| DATE: 11/29/23 | | | | | | | | | |
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COVER SHEET

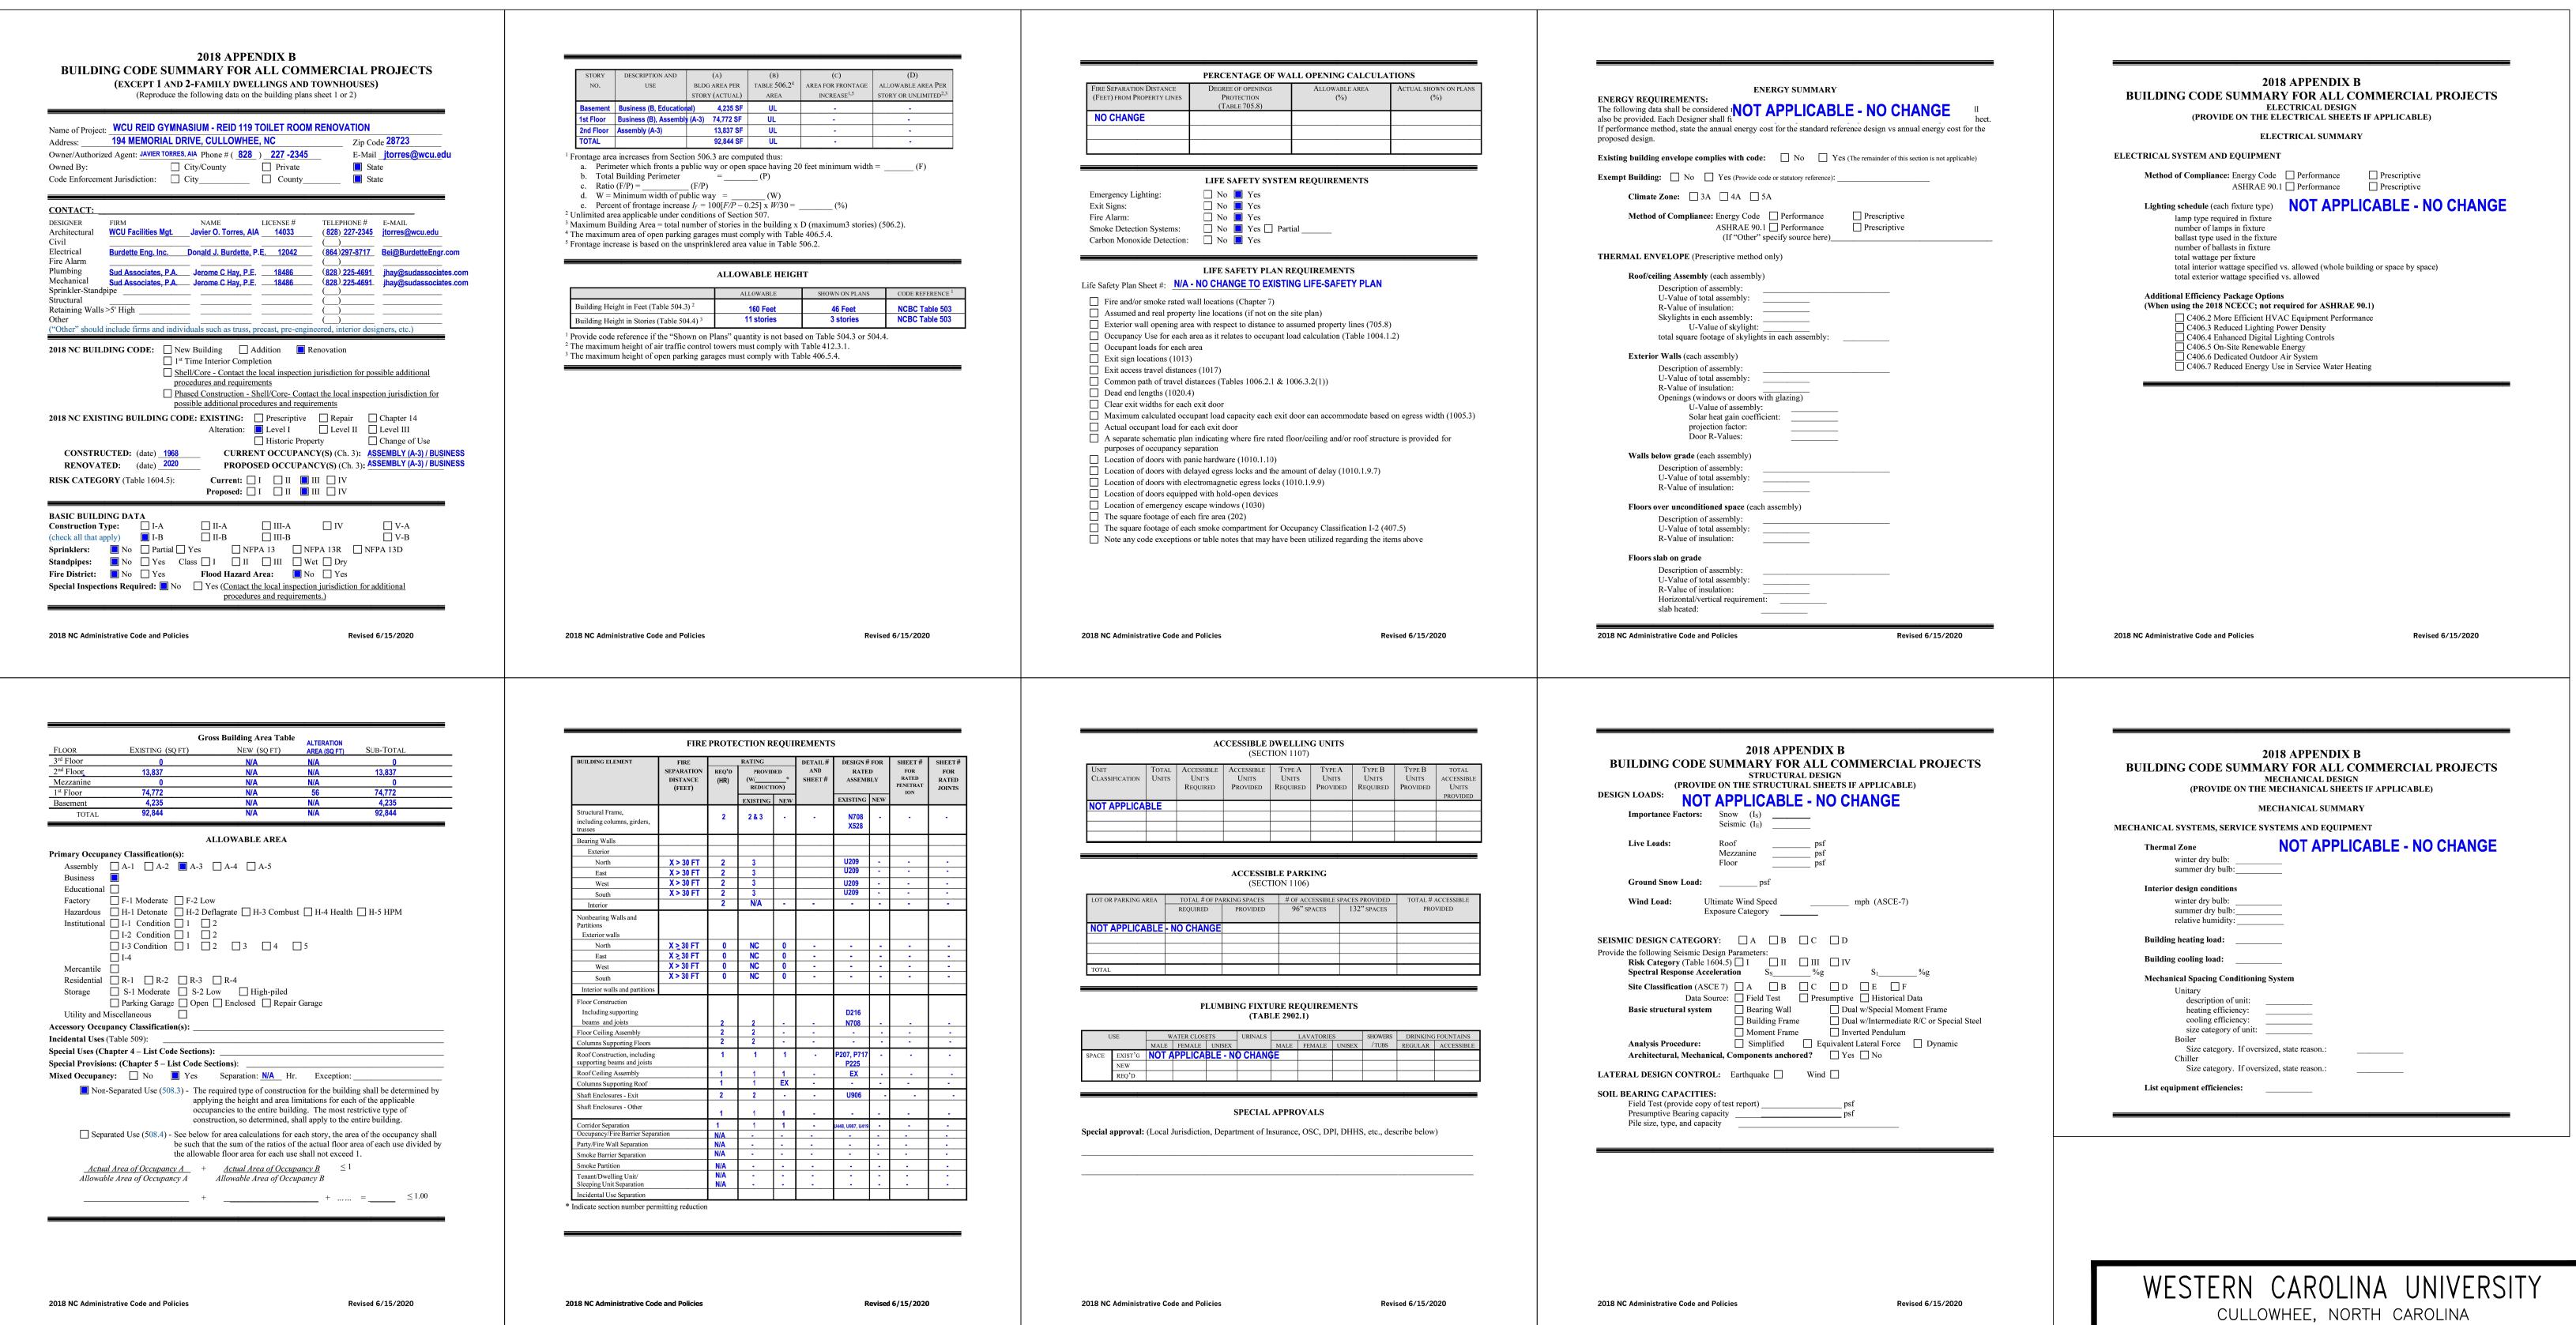


REID GYMNASIUM


REID 119 TOILET ROOM RENOVATION SCO ID #: 23-26576-01A

WCU"#: 2023-008

BUILDING CODE SUMMARY - APPX. B

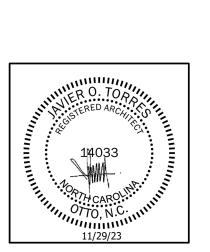

| DATE: 11/29/23 | | | | | | | | | |
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| | SC | | | | | | | | |
| DRAWN BY: JT | | | | | | | | | |
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| | DRAWING NUMBER: G01 | | | | | | | | |

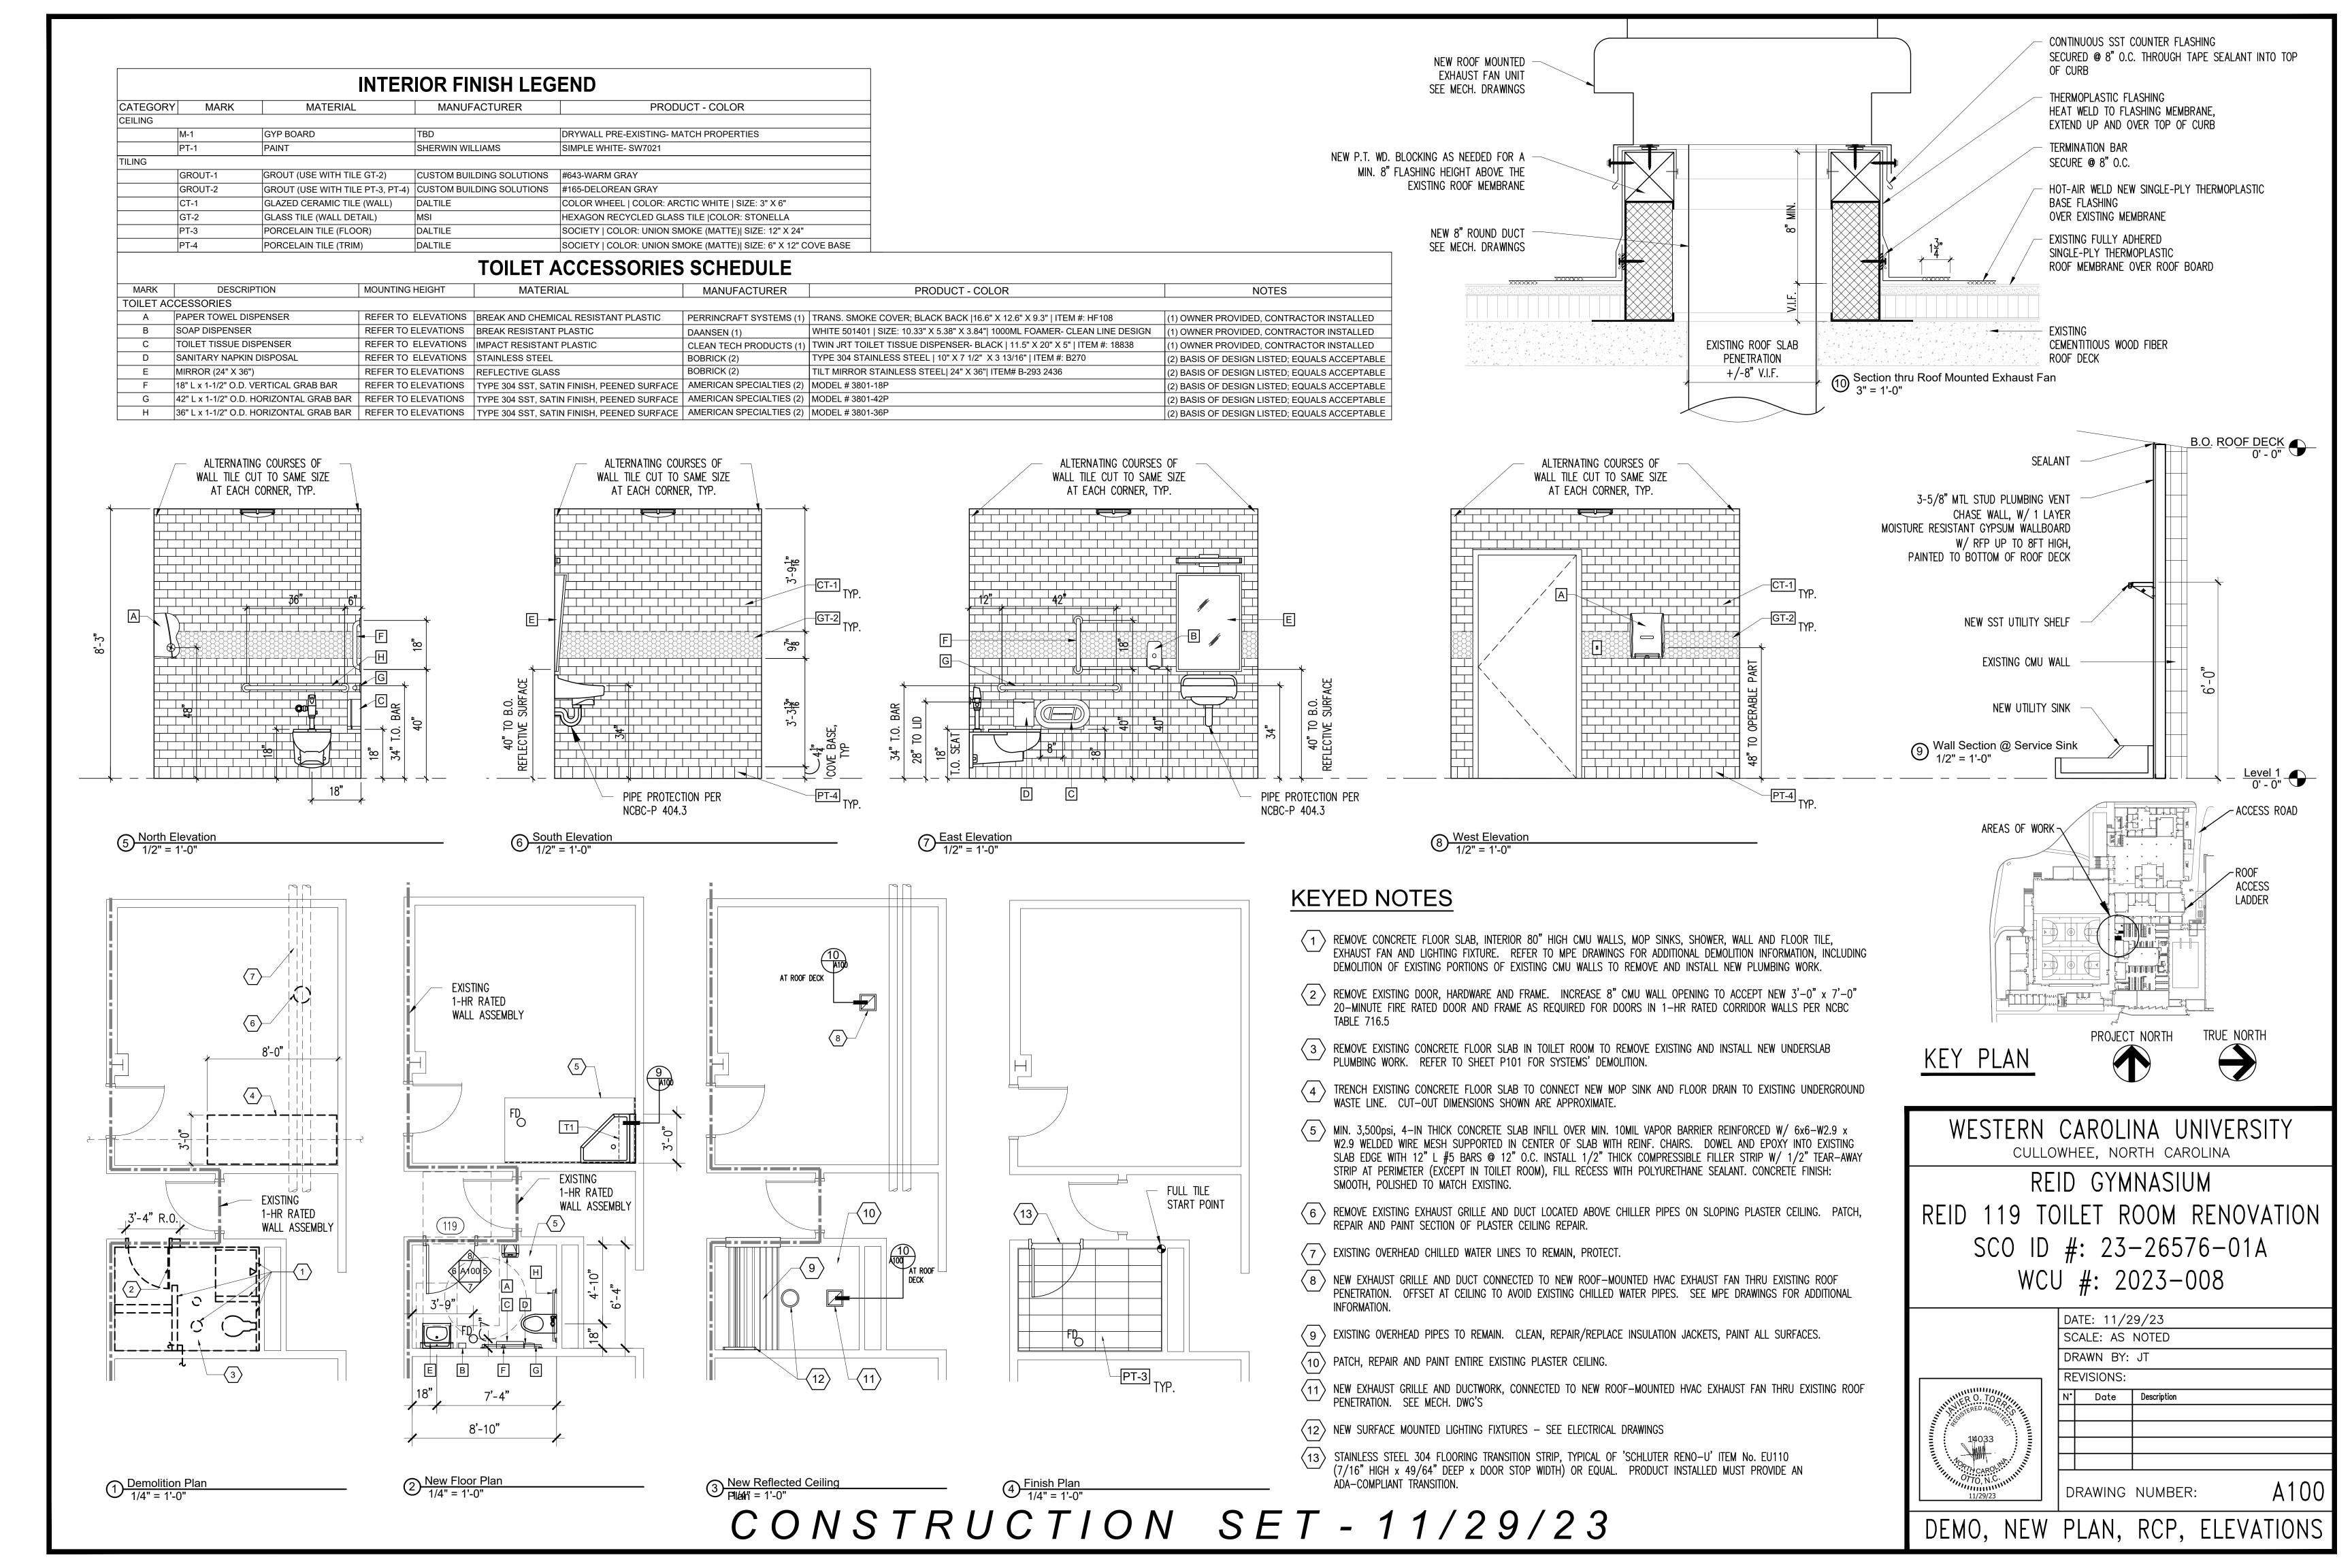

| PLUME | SING LEGEND |
|--|--|
| SYMBOL | DESCRIPTION |
| | EXISTING COLD WATER |
| | NEW COLD WATER |
| | EXISTING HOT WATER |
| | NEW HOT WATER |
| | EXISTING SANITARY WASTE |
| | NEW SANITARY WASTE |
| | EXISTING VENT |
| | NEW VENT |
| —————————————————————————————————————— | FLOOR CLEAN-OUT |
| P | SHOCK ABSORBER |
| ◆ | CONNECTION POINT FROM EXISTING TO NEW |
| —————————————————————————————————————— | HOSE BIBB |
| P-1 | FIXTURE IDENTIFICATION(SEE SPECIFICATIONS) |
| | BALL VALVE |
| ♦ FD | FLOOR DRAIN |
| 1////// | ITEMS TO BE DEMOLISHED |

| | | | | | | PLUMBING FIXTURE SCHEDULE | | | | | |
|-------|-------------------|----------------------|-----------------|---------------------|--------------------|--|------|--------------------------|--------|------|--|
| MARK | MANU. * | ANU. * MODEL * FIXTU | FIXTURE TYPE | MOUNTING | COLOR | COLOR DESCRIPTION | | FIXTURE CONNECTION SIZES | | | |
| | | | | | | | | HW | WASTE | VENT | |
| P-1 - | FIAT | TSBC1612 | MOP BASIN | FLOOR | TERRAZZO | 36" X 36" X 12" HIGH PRECAST TERRAZZO CORNER MOP BASIN, STAINLESS STEEL THRESHOLD CURB CAP, (2) 36" HIGH STAINLESS STEEL SPLASH GAURDS, INTEGRAL 3" CAST DRAIN | | | | | |
| F-1 | AMERICAN STANDARD | 8344 | FAUCET | WALL @ 32" AFF | CHROME | WALL MOUNT PROVIDE WALL BRACE, MINIMUM 4" SPOUT, HEAVY DUTY CAST BRASS, VACUUM BREAKER, HOSE THREADED OUTLET, PAIL HOOD, INTEGRAL STOPS IN SHANK, LEVEL HANDLES, | 3/4" | 3/4" | 3" | 2" | |
| P-2 | AMERICAN STANDARD | 2294.011EC | WATER CLOSET | FLOOR, RIM @ 16.25" | WHITE | WALL MOUNT, BACK OUTLET, ELONGATED BOWL, VITREOUS CHINA, SIPHON JET ACTION, FULLY GLAZED TRAPWAY, CENTER INLET 1-1/2" TOP SPUD, HARD PLASTIC TOILET SEAT, ZURN CARRIER Z1202-1N_4, FOR SINGLE TOILET, ADA/NC ACCESSIBILITY CODE COMPLIANT. FURNISHED BY OWNER. | | | | | |
| | SLOAN | 111-1.28 | FLUSH VALVE | TOP SPUD | CHROME | EXPOSED MANUAL FLUSH VALVE, 1.28 GPF, DIAPHRAGM TYPE, BACK PRESSURE VACUUM BREAKER, NON HOLD OPEN HANDLE, ADA/NC ACCESSIBILITY CODE COMPLIANCE. FURNISHED BY OWNER. | 1" | | 3" | 2" | |
| P-3 | AMERICAN STANDARD | 0356.421 | LAVATORY | WALL @ 34" AFF | WHITE | 15 x 10 x 6.5 RECTANGULAR BOWL, VITREOUS CHINA, FRONT OVERFLOW DRAIN, SELF DRAINING DECK WITH BACKSPLASH, 1-1/4" BRASS P-TRAP WITH CO PLUG, GRID DRAIN, INSULATED PIPE KIT. D, SINGLE HOLE PUNCH, ADA/NC ACCESSIBILITY CODE COMPLIANCE. FURNISHED BY OWNER. | | | | | |
| | KOHLER | K-97283-4 | LAVATORY FAUCET | DECK | CHROME | DECK MOUNTED, SINGLE HANDLE, HEAVY DUTY CAST BRASS, SINGLE HOLE MOUNTING, 1-1/4" BRASS P-TRAP WITH CO PLUG, GRID DRAIN, INSULATED PIPE KIT, 0.5 GPM, ADA/NC ACCESSIBILITY CODE COMPLIANCE. FURNISHED BY OWNER. | 1/2" | 1/2" | 1-1/4" | 2" | |
| FD | ZURN | Z-1726 | FLOOR DRAIN | FLOOR | STAINLESS STEEL | 5" DIAMETER STRAINER FLOOR DRAIN WITH ADJUSTABLE TOP. FIELD VERIFY REQUIRED CONNECTION SIZE WITH EXISTING WASTE PIPING SIZES. | | | 3" | | |

PLUMBING SPECIFICATIONS:

* BASIS OF DESIGN, EQUALS BY KOHLER, TOTO, T&S BRASS, CHICAGO, ZURN, WATTS, JUST, ACORN AND WILOUGHBY.

INTENT: THESE OUTLINE SPECIFICATIONS AND ACCOMPANYING DRAWINGS DESCRIBE SCOPE OF WORK REQUIRED FOR PLUMBING WORK. LABOR AND MATERIAL SHALL BE PROVIDED AS REQUIRED FOR A COMPLETE, WORKMANLIKE INSTALLATION OF ALL WORK SHOWN ON DIAGRAMMATIC DRAWINGS AND/OR AS SPECIFIED HEREIN.

CODES, PERMITS, AND INSPECTIONS: ALL WORK SHALL BE IN ACCORDANCE WITH APPLICABLE STATE AND LOCAL CODES AND NFPA REQUIREMENTS. OBTAIN ALL PERMITS REQUIRED, GIVE ALL LEGAL NOTICES, AND HAVE ALL WORK INSPECTED AS REQUIRED BY LOCAL OR STATE LAW.

WORKMANSHIP: COMPETENT SKILLFUL WORKMEN SHALL DO ALL WORK IN A FINISHED, THOROUGHLY SUBSTANTIAL AND CRAFTSMANLIKE MANNER. THIS IS INTENDED TO REFER PARTICULARLY TO SMALLER DETAILS NECESSARY BUT USUALLY NOT SPECIFIED OR INDICATED ON THE DRAWINGS. ALL SUB-STANDARD WORK, INSTALLED BY THIS CONTRACTOR, SHALL BE REPLACED BY THIS CONTRACTOR AT NO ADDITIONAL EXPENSE TO THE OWNER. IF THIS CONTRACTOR DAMAGES EXISTING WORK, HE SHALL PAY THE COST OF REPLACEMENT OF THE DAMAGED WORK AT NO ADDITIONAL EXPENSE TO THE OWNER. ENGINEER SHALL BE THE JUDGE OF WORKMANSHIP AND HIS OPINION SHALL BE FINAL.

SUPERVISION: CONSTANTLY SUPERVISE THE WORK FROM THE BEGINNING TO COMPLETION AND FINAL REVIEW.

PROGRESS OF WORK: DILIGENTLY PERFORM THE WORK AS RAPIDLY AS POSSIBLE AND MINIMIZE DISCOMFORT OF BUILDING OCCUPANTS.

EQUIPMENT LOCATIONS: DETERMINE EXACT EQUIPMENT AND MATERIALS LOCATIONS TO PROVIDE BEST ARRANGEMENT AND TO FACILITATE PROPER MAINTENANCE AND SERVICING OF EQUIPMENT. COORDINATE CLOSELY WITH

EQUIPMENT SUPPORTS: PROVIDE ALL NECESSARY SUPPORTS FOR MOUNTING ALL EQUIPMENT AND PIPING. SUCH SUPPORTS TO BE INSTALLED IN A NEAT AND WORKMANLIKE MANNER.

INTERFERENCES: PLANS ARE GENERALLY DIAGRAMMATIC. CONTRACTOR SHALL AVOID INTERFERENCES WITH CONDUITS, PIPING, EQUIPMENT, ARCHITECTURAL AND STRUCTURAL WORK. NECESSARY OFFSETS IN FITTINGS, ETC., REQUIRED TO PROPERLY INSTALL EQUIPMENT SO AS TO TAKE UP A MINIMUM SPACE SHALL BE FURNISHED AND INSTALLED BY THIS CONTRACTOR WITH NO ADDITIONAL EXPENSE TO THE OWNER.

UNDERWRITER'S LABORATORIES APPROVAL: ALL ELECTRICAL EQUIPMENT FURNISHED SHALL BE UL APPROVED AND SHALL BE LABELED OR LISTED BY UL. NO EQUIPMENT SHALL BE APPROVED WHICH FAILS TO MEET THESE CONDITIONS.

STORAGE OF MATERIAL: CONSULT WITH THE OWNER FOR STORAGE SPACE AT THE JOB SITE IF REQUIRED. STORAGE SPACE MUST BE SECURED AND CONTRACTOR'S REPRESENTATIVE MUST BE ON JOB BEFORE ANY MATERIAL MAY BE RECEIVED. OWNER IS NOT RESPONSIBLE FOR SECURITY.

<u>CLEAN-UP:</u> REMOVE ALL DEBRIS DUE TO THIS WORK AND REPAIR, CLEAN AND REPLACE ALL SURFACES DAMAGED OR SOILED AS A RESULT OF THIS WORK AT NO ADDITIONAL EXPENSE TO THE OWNER. REMOVAL OF DEBRIS SHALL BE DAILY OR AS REQUIRED TO MAINTAIN SAFE, CLEAN WORKING CONDITIONS.

SHOP DRAWINGS/SUBMITTAL DATA: SUBMIT ELECTRONIC COPIES OF SHOP DRAWINGS/SUBMITTAL DATA FOR ALL EQUIPMENT AND MATERIALS FOR REVIEW. CLEARLY IDENTIFY ALL ITEMS.

PLACING IN SERVICE, TESTS, INSTRUCTIONS AND MAINTENANCE: MAKE ALL NECESSARY TESTS, TRIAL OPERATIONS, ETC., REQUIRED AND DIRECTED BY APPLICABLE CODES AND STANDARDS AND THE DESIGNER TO PROVE THAT ALL SYSTEMS ARE IN COMPLETE SERVICEABLE CONDITION AND WILL FUNCTION AS INTENDED.

WARRANTY CERTIFICATE FOR EQUIPMENT WILL COMMENCE UPON DATE OF ACCEPTANCE OF WORK BY OWNER. SUBMIT WRITTEN CERTIFICATE WITH MAINTENANCE DATA.

WARRANTY: CORRECT ANY DEFECTS IN WORKMANSHIP AND/OR MATERIAL WHICH OCCUR DURING THE FIRST YEAR OF OPERATION.

HANGERS, SUPPORTS AND ANCHORS: SUPPORT AND FASTEN ALL CONDUIT, PIPING, DUCTWORK, EQUIPMENT, ETC., SECURELY IN PLACE. SPACE, SECURE AND ADJUST HANGERS WITHOUT DEFLECTION OR SAG. CHAIN, STRAP, PERFORATED STRAP, WIRE HANGERS, OR WOOD PLUGS ARE PROHIBITED.

PROVIDE STEEL SUPPORTS, ANCHORS, FRAMES, BRACING, PLATES, BOLTS, NUTS, WASHERS, ETC., INCIDENTAL TO INSTALLATION OF WORK AS SPECIFIED OR REQUIRED.

SUPPORT EQUIPMENT FROM THE STRUCTURE IN AN APPROVED MANNER. NO PORTION OF THE STRUCTURE SHALL BE OVERSTRESSED BY THE HANGING OPERATION OR BY THE FINAL SUPPORTS. PROVIDE AUXILIARY STRUCTURAL MEMBERS WHERE REQUIRED BETWEEN MEMBERS OF THE STRUCTURE. INSTALL IN ACCORDANCE WITH THE REQUIREMENTS OF THE AISC AND ANSI B31.9.

ALL EQUIPMENT, UNLESS SHOWN OTHERWISE, SHALL BE SECURELY ATTACHED TO THE BUILDING STRUCTURE IN AN APPROVED MANNER. ATTACHMENTS THAT ARE, IN THE OPINION OF THE DESIGNER, INADEQUATE SHALL BE REPLACED AS DIRECTED.


BALL VALVES: RATED FOR 150 PSI SATURATED STEAM PRESSURE, 400 PSI WOG PRESSURE; TWO-PIECE CONSTRUCTION; WITH BRONZE BODY CONFORMING TO ASTM B 62, FULL PORT, CHROME-PLATED BRASS BALL, REPLACEABLE "TEFLON" OR "TFE" SEATS AND SEALS, BLOWOUT-PROOF STEM, AND VINYL-COVERED STEEL HANDLE.

WATER HAMMER ARRESTERS: BELLOWS TYPE, WITH STAINLESS STEEL CASING AND BELLOWS, PRESSURE RATED FOR 250 PSI, TESTED AND CERTIFIED IN ACCORDANCE WITH PDI STANDARD WH-201 OR PISTON OPERATED MEETING ANSI/ASME A112.26.1M-1984, OR ASSE STANDARD NO. 1010. SIZES TO MATCH FIXTURE UNITS SUPPLYING MAINS. INSTALL PER MANUFACTURER'S RECOMMENDATIONS. SEE WATER DISTRIBUTION DIAGRAM FOR LOCATION. PROVIDE A BALL VALVE PRECEDING WATER HAMMER ARRESTER.

ABOVE GRADE SANITARY AND VENT PIPE AND FITTINGS (CONCEALED AREAS): SERVICE WEIGHT CAST IRON WITH NO HUB CONNECTIONS.

DOMESTIC WATER PIPE AND FITTINGS: COPPER TUBE: ASTM B 88, TYPE L WATER TUBE, DRAWN TEMPER. WROUGHT COPPER SOLDER-JOINT FITTINGS: ANSI B 16.22, STREAMLINED PATTERN. SOLDER FILLER METAL: ASTM B 32, 95-5 TIN-ANTIMONY.

PIPE INSULATION: PROVIDE 1" FIBERGLASS INSULATION FOR COLD WATER AND HOT WATER.

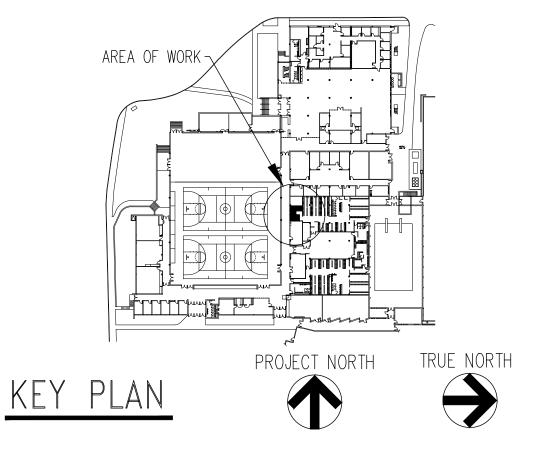

WESTERN CAROLINA UNIVERSITY

CULLOWHEE, NORTH CAROLINA

REID GYMNASIUM REID 119 TOILET ROOM RENOVATION SCO ID #: 23-26576-01A

WCU #: 2023-008



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| DATE: 11/29/23 | | | | | | | | |
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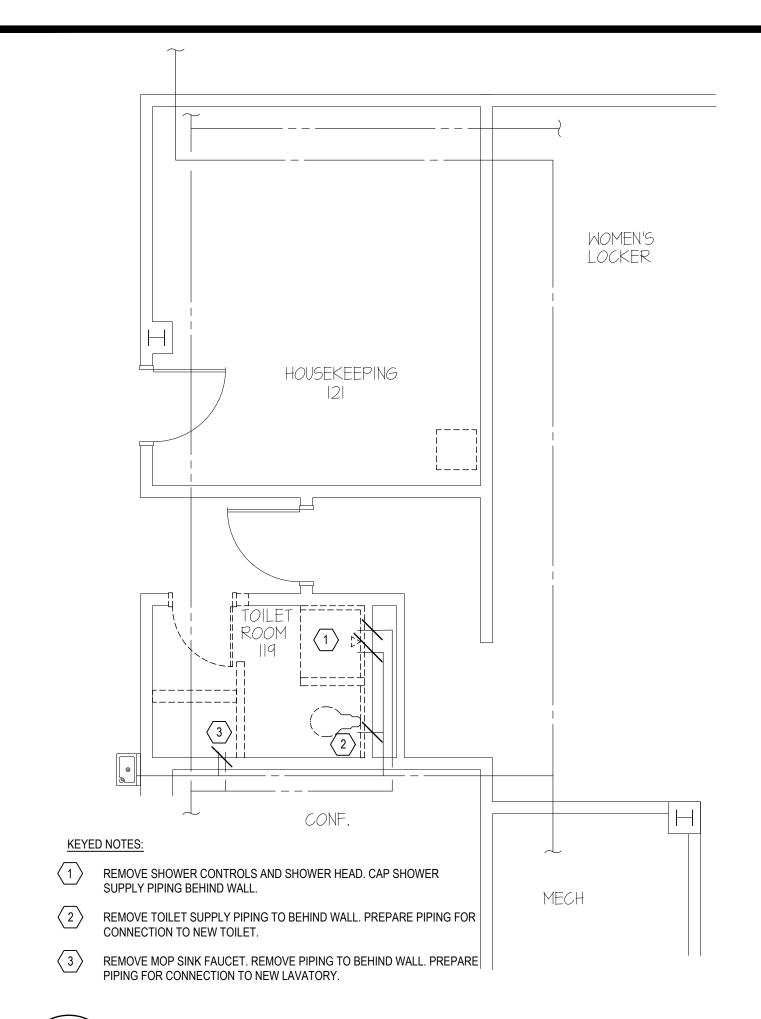
P100 LEGEND, NOTES & SCHEDULE

SUD ASSOCIATES, P.A. CONSULTING ENGINEERS


LICENSE NO. C-0315

PROJECT #NC49X004 1813 CHAPEL HILL ROAD **DURHAM, NC 27707** (919) 493-5277


90 SOUTHSIDE AVE. SUITE 350 ASHEVILLE, NC 28801 (828) 255-4691




PLUMBING PLAN - SUPPLY DEMOLITION P101 / 1/4" = 1'-0"

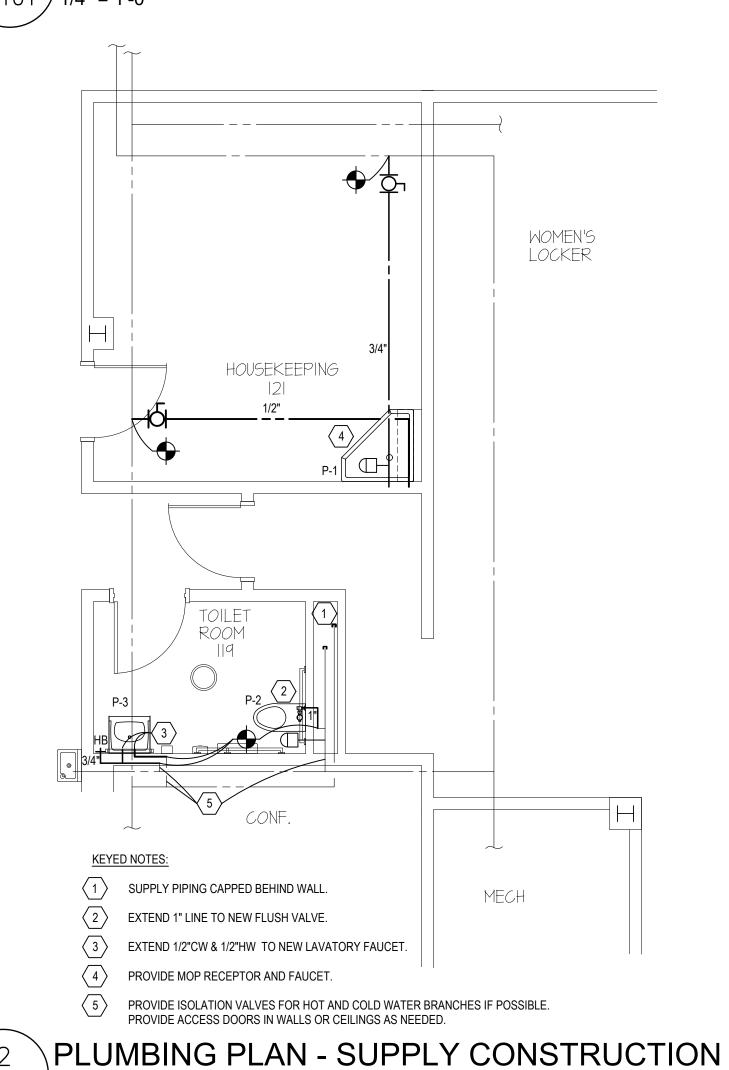

P101 / 1/4" = 1'-0"

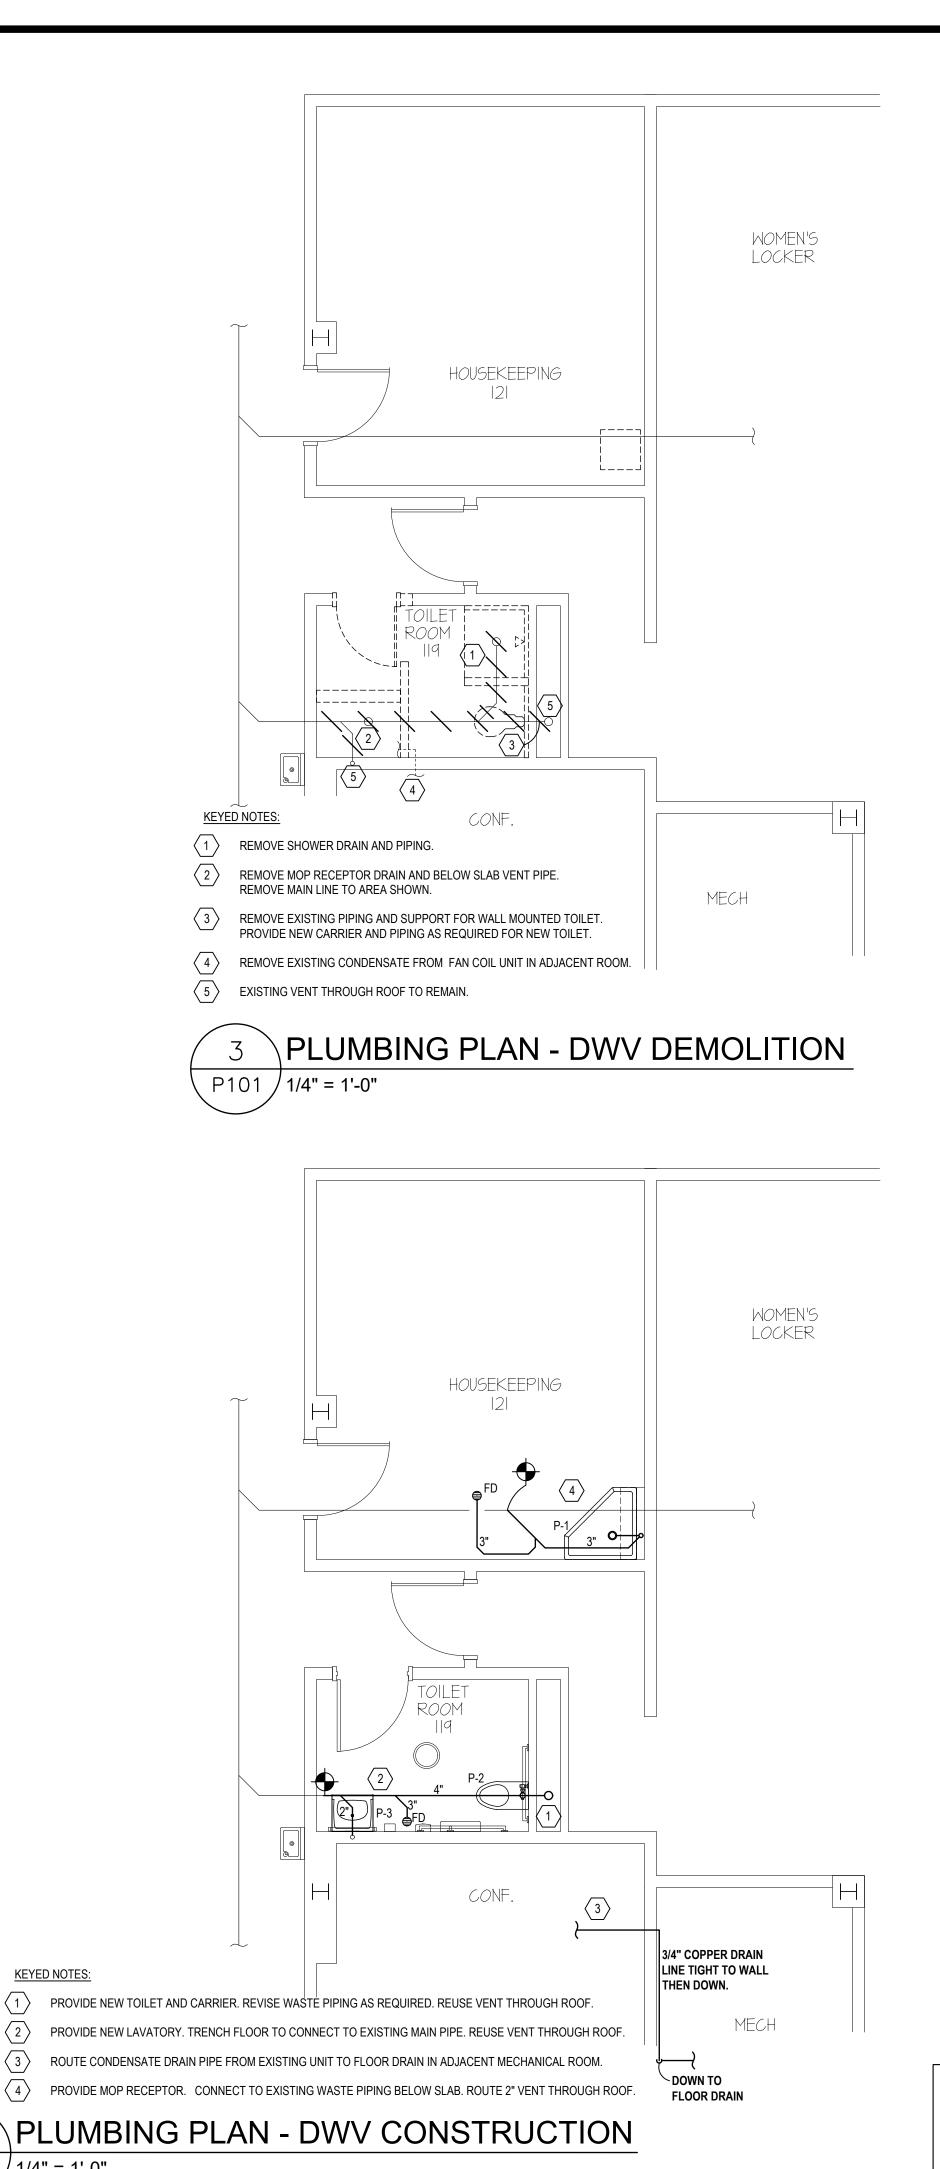

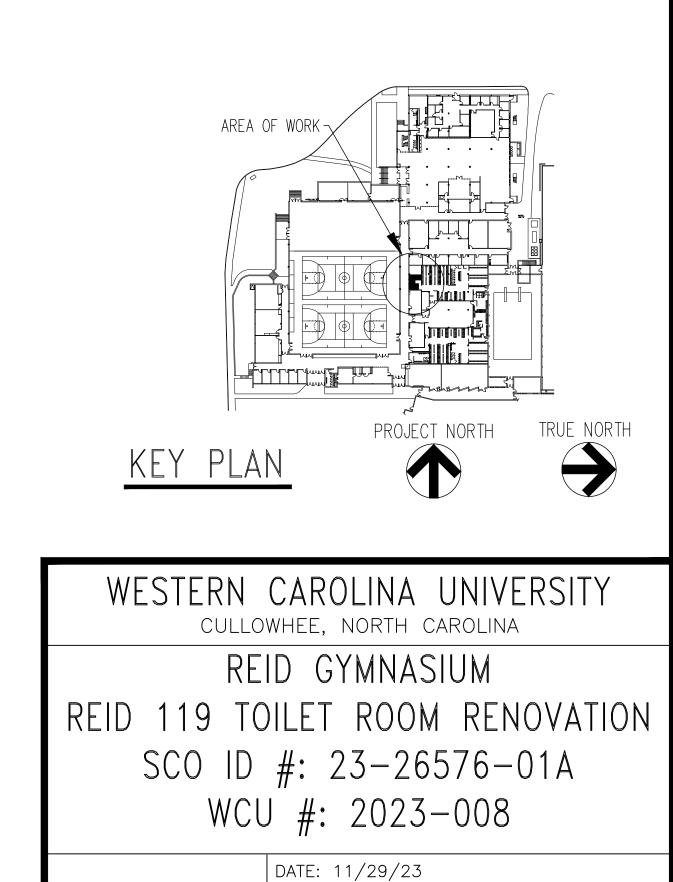



1813 CHAPEL HILL ROAD DURHAM, NC 27707 (919) 493-5277

90 SOUTHSIDE AVE. SUITE 350 ASHEVILLE, NC 28801 (828) 255-4691


SCALE: AS NOTED DRAWN BY: DCR **REVISIONS:** N° Date Description P101 DRAWING NUMBER:

TRUE NORTH

DEMOLITION & NEW PLAN

CONSTRUCTION SET - 11/29/23


P101 / 1/4" = 1'-0"

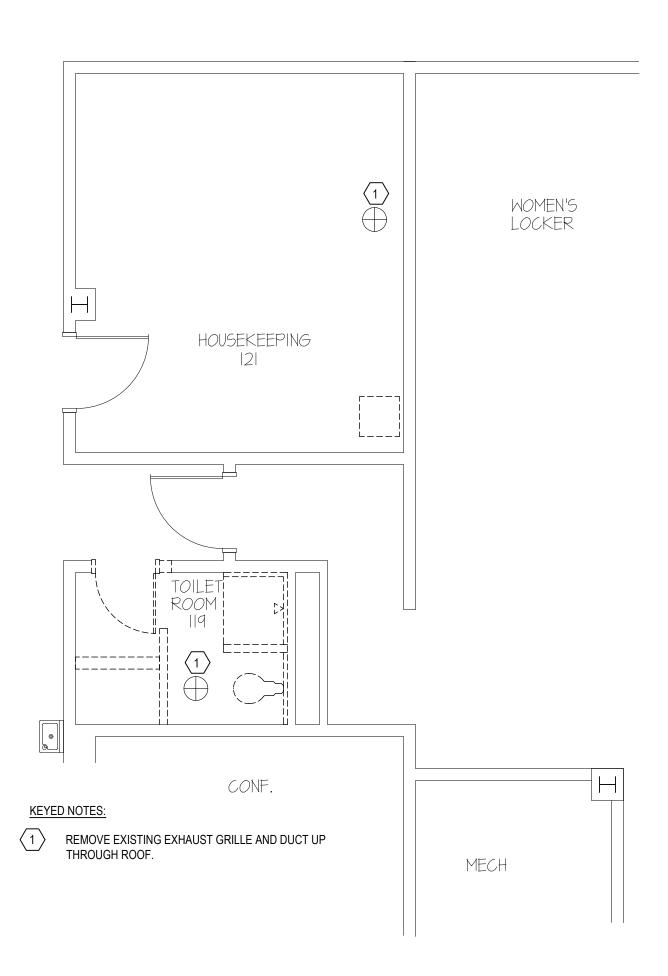



MECHANICAL DEMOLITION GENERAL NOTES:

- 1. UNLESS OTHERWISE INDICATED DIVISION 23 CONTRACTOR IS RESPONSIBLE FOR ALL CUTTING, CORE-DRILLING AND PATCHING REQUIRED TO INSTALL MECHANICAL WORK.
- 2. MECHANICAL CONTRACTOR IS RESPONSIBLE FOR COORDINATING MECHANICAL RELATED WORK WITH OTHER TRADES. MC IS CAUTIONED THAT IT IS TOTALLY HIS RESPONSIBILITY TO COORDINATE HANGERS AND SUPPORTS WITH OTHER TRADES.
- 3. ITEMS SHOWN TO BE DEMOLISHED MAY OR MAY NOT BE CORRECTLY LABELED OR LOCATED. EXAMINE EXIST. CONDITIONS OF ALL AREAS AND FIELD VERIFY/ IDENTIFY ALL UTILITIES BEFORE STARTING DEMOLITION OR NEW CONSTRUCTION. VERIFICATION/IDENTIFICATION SHALL INCLUDE TRACING EACH UTILITY TO DETERMINE ITS EXACT ORIGIN AND THE AREA OR EQUIPMENT THE UTILITY SERVES.
- 4. ALL DEMOLITION WORK SHALL BE PERFORMED WITH "DUE CARE AND DILIGENCE" SO AS TO PREVENT THE ARBITRARY DESTRUCTION OR INTERRUPTION OF CONCEALED UTILITIES WHICH ARE INTENDED TO REMAIN IN USE AND THE ROUTING OF WHICH COULD NOT BE PREDETERMINED UNTIL DEMOLITION WAS STARTED. ALL SUCH DISCOVERIES OF UTILITIES DURING THE DEMOLITION PROCESS WHICH ARE IN A LOCATION DIFFERENT FROM THAT INDICATED, CHANGE DIRECTION FROM FLOOR TO FLOOR, ETC., OR ARE UNIDENTIFIED, SHALL BE REPORTED TO THE ARCHITECT BEFORE REMOVAL.
- 5. VISIT THE SITE PRIOR TO BID DATE AND EXAMINE ALL AREAS TO BE DEMOLISHED AND RENOVATED. THOROUGHLY FAMILIARIZE YOURSELF WITH EXIST. CONDITIONS. NO EXTRA COMPENSATION WILL BE GIVEN FOR FAILURE TO THOROUGHLY EXAMINE EXIST. CONDITIONS TO DETERMINE THE EXACT SCOPE OF DEMOLITION WORK. "KEYED" NOTES ON THE DEMOLITION DWGS. ARE PROVIDED TO ASSIST BIDDERS TO DETERMINE THE SCOPE OF DEMOLITION WORK.
- 6. THE OWNER HAS THE RIGHT TO FIRST REFUSAL ON ALL ITEMS REMOVED DURING THE DEMOLITION PHASE OF THIS PROJECT. ITEMS NOT INDICATED TO BE TURNED OVER TO THE OWNER SHALL BECOME THE PROPERTY OF THE CONTRACTOR, AND SHALL BE REMOVED FROM THE PREMISES ON A DAILY BASIS.
- 7. EXISTING AREAS WHETHER WITHIN OR WITHOUT THE "GENERAL LIMITS OF CONSTRUCTION", SHALL BE REPAIRED WHERE ANY DAMAGE HAS OCCURRED DUE TO CONST. BY THE CONTRACTOR.
- 8. ALL SHUTDOWNS OF THE EXIST. UTILITIES SHALL BE SCHEDULED IN ADVANCE WITH
- 9. CONTRACTOR IS RESPONSIBLE FOR SEALING ALL DUCTING PENETRATIONS THROUGH ALL NEW NON-RATED WALLS TO PREVENT SOUND TRANSFER. GYPSUM WALL BD. "MUD" MAY BE USED.

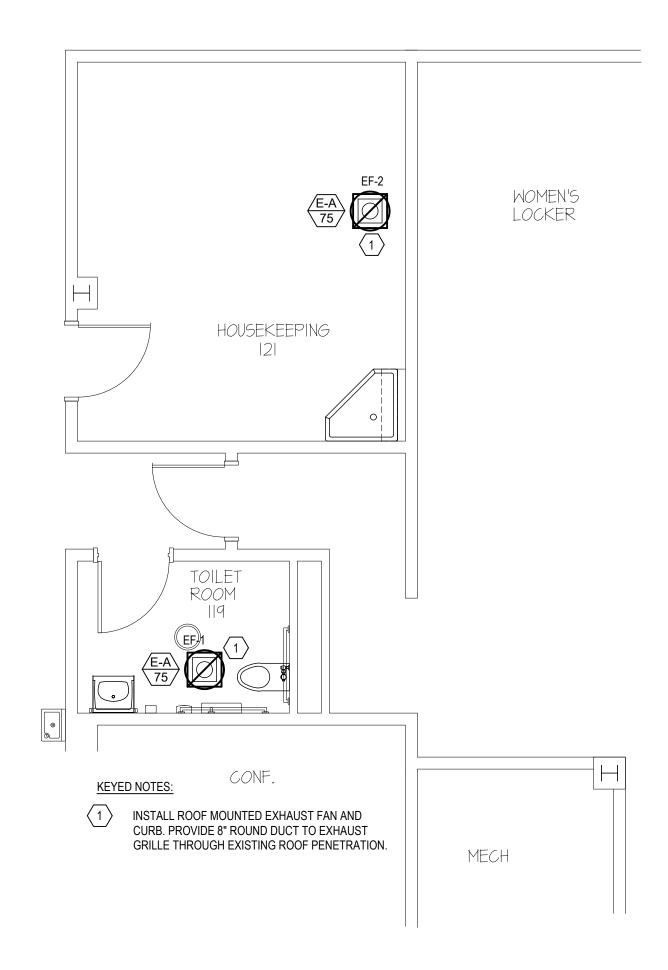




| | EXHAUST FAN SCHEDULE | | | | | | | | | | |
|-----------|----------------------|---------|------------------|----------|------------------|-----|---------|-----------|-------|-------------|---------|
| MARK | MANU.* | MODEL * | AREA SERVED | MOUNTING | TYPE | CFM | SP (in) | MAX SONES | HP | VOLTS/PHASE | NOTES |
| EF-1 | GREENHECK | G-060 | TOILET 119 | ROOF | DOWNBLAST/DIRECT | 75 | 0.125 | 1.7 | 1/200 | 120 / 1 | 1, 3, 4 |
| EF-2 | GREENHECK | G-060 | HOUSEKEEPING 121 | ROOF | DOWNBLAST/DIRECT | 75 | 0.125 | 1.7 | 1/200 | 120 / 1 | 1, 2, 4 |
| * BASIS C | BASIS OF DESIGN | | | | | | | | | | |

- 1. PROVIDE 14" FACTORY ROOF CURB, SECURE FAN TO CURB.
- 2. WIRE FOR MANUALLY SWITCHED OPERATION.
- 3. SWITCH WITH LIGHTS.
- 4. PROVIDE INTEGRAL FACTORY DISCONNECT.

| | EXHAUST GRILLE SCHEDULE | | | | | | | | | |
|-----------|-------------------------|------------|-------------------|--------------|-----------|-----------|-----------|----------|--------|-------|
| MARK | MANU. * | MODEL * | TYPE | MOUNTING | CFM RANGE | FACE SIZE | NECK SIZE | MATERIAL | FINISH | NOTES |
| E-A | PRICE | SERIES 630 | SINGLE DEFLECTION | HARD CEILING | 75 | 10" X 10" | 12" X 12" | ALUMINUM | WHITE | : =1 |
| * BASIS O | BASIS OF DESIGN | | | | | | | | | |

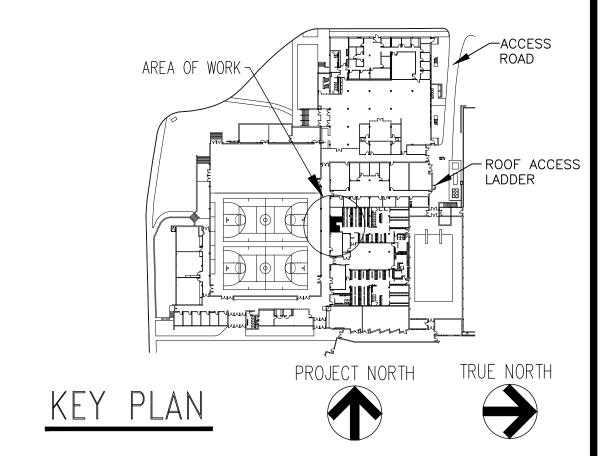

WESTERN CAROLINA UNIVERSITY CULLOWHEE, NORTH CAROLINA

REID GYMNASIUM

REID 119 TOILET ROOM RENOVATION SCO ID #: 23-26576-01A WCU #: 2023-008

| DA | DATE: 11/29/23 | | | | | | | |
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DRAWING NUMBER:

DEMOLITION & NEW PLAN

M101

SUD ASSOCIATES, P.A. CONSULTING ENGINEERS LICENSE NO. C-0315

PROJECT #NC49X004 1813 CHAPEL HILL ROAD **DURHAM, NC 27707** (919) 493-5277

90 SOUTHSIDE AVE. SUITE 350 ASHEVILLE, NC 28801 (828) 255-4691


CONSTRUCTION SET - 11/29/23

| | WCU REID GYMNASIUM TOILET - LIGHT FIXTURE SCHEDULE | | | | | | | | | |
|------|--|--|------------------|------|-------|-------------------|--------------|-------|--|--|
| TYPE | DESCRIPTION | OEM & MODEL #: BASIS OF DESIGN * | MOUNTING | VOLT | LAMPS | BALLAST /FIXT. | VA/ FIXT. | NOTES | | |
| L1 | 13" FLUSH MOUNT LED ROUND, 950 LUMENS, 120 VOLT, 80 CRI, 3500°K, BRUSHED NICKEL | LITHONIA LIGHTING #FMSATL-13-20835-BN | CEILING SURFACE | 120V | | 1 | 14.6 | | | |
| L2 | 24" WALL MOUNT LED, 1550 LUMENS, 120 VOLT, 90 CRI, 3500°K, BRUSHED NICKEL | LITHONIA LIGHTING #FMVCSLS-24IN-MVOLT-35K-90CRI-BN | WALL MOUNT @ 7' | 120V | | 1 | 27 | | | |
| | WALL MOUNTED DUAL TECHNOLOGY OCCUPANCY SENSOR SWITCH, 120/277 VAC, LINE RATED 1000 WATT, GREY DEVICE COLOR, STAINLESS STEEL SWITCH PLATE | LEGRAND-WATTSTOPPER TYPE #DSW-301 OR EQUIVALENT | WALL MOUNT @ 48" | 120V | | N/A | N/A | | | |

* BASIS OF DESIGN, OTHER EQUIVALENT FIXTURES MAY BE SUBMITTED AND ARE SUBJECT TO SUBMITTALS REVIEW. COLUMBIA, WILLIAMS, AND DAYBRITE ARE ACCEPTABLE.


- . ADJUST HEADS TO COVER EGRESS PATH, REVIEW WITH OWNER
- 2. UNIT TO BE "WET LOCATION" RATED AND GOOD FOR 0° F OPERATION
- X: FINISH/COLOR BY ARCHITECT

XX: MOUNTING & ACCESSORIES BY EC

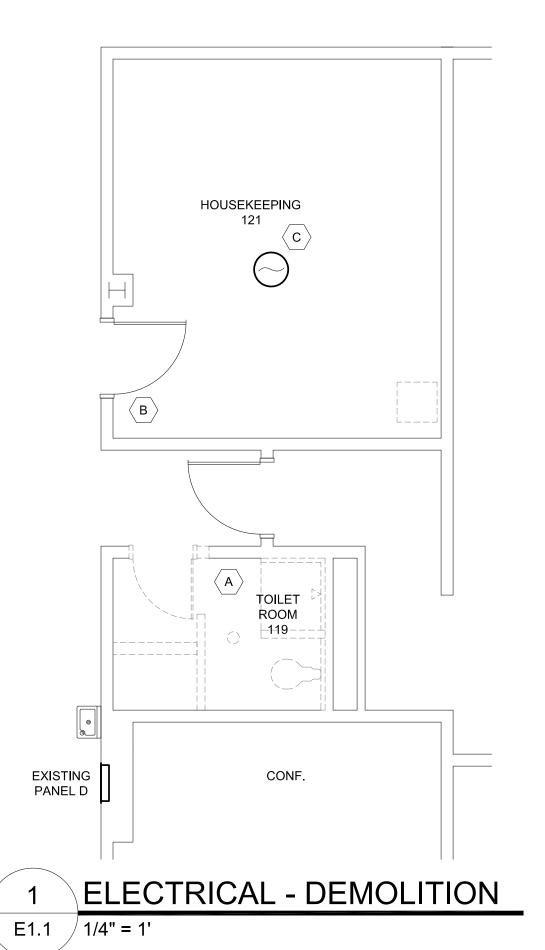

DEMOLITION KEYED NOTES

- THE E.C. SHALL REMOVE THE EXISTING LIGHTING FIXTURE, SWITCH AND WIRING IMPACTED BY THE NEW CONSTRUCTION IN SUCH A MANNER AS TO FACILITATE RE-USING THE EXISTING LIGHTING CIRCUIT IN THE NEW WORK. SEE THE ARCHITECTURAL DEMOLITION PLANS FOR ADDITIONAL INFORMATION. COORDINATE THE PRECISE ELECTRICAL REMOVAL WITH THE G.C. PRIOR TO COMMENCING WORK. PROVIDE J-BOXES AND BLANK COVER PLATES TO TERMINATE AND MAKE
- THE E.C. SHALL FIELD VERIFY THE EXISTING LIGHTING CIRCUIT AND WIRING AND REMOVE A LIGHTING OUTLET BOX OR SWITCH BOX IN SUCH A MANNER AS TO FACILITATE RE-USING THE EXISTING LIGHTING CIRCUIT FOR POWERING THE NEW EXHAUST FAN IN THE NEW WORK. SEE THE ARCHITECTURAL DEMOLITION PLANS FOR ADDITIONAL INFORMATION. COORDINATE THE PRECISE ELECTRICAL REMOVAL WITH THE G.C. PRIOR TO COMMENCING WORK. PROVIDE J-BOXES AND BLANK COVER PLATES TO TERMINATE AND MAKE SAFE ANY UNUSED WIRING.
- THE E.C. SHALL PROVIDE PLASTIC AND REMOVEABLE MASKING TAPE TO COVER THE EXISTING SMOKE DETECTOR IN PLACE DURING CONSTRUCTION SO AS TO PROTECT THE SMOKE DETECTOR FROM DUST, DEBRIS, WATER AND OR MOISTURE.

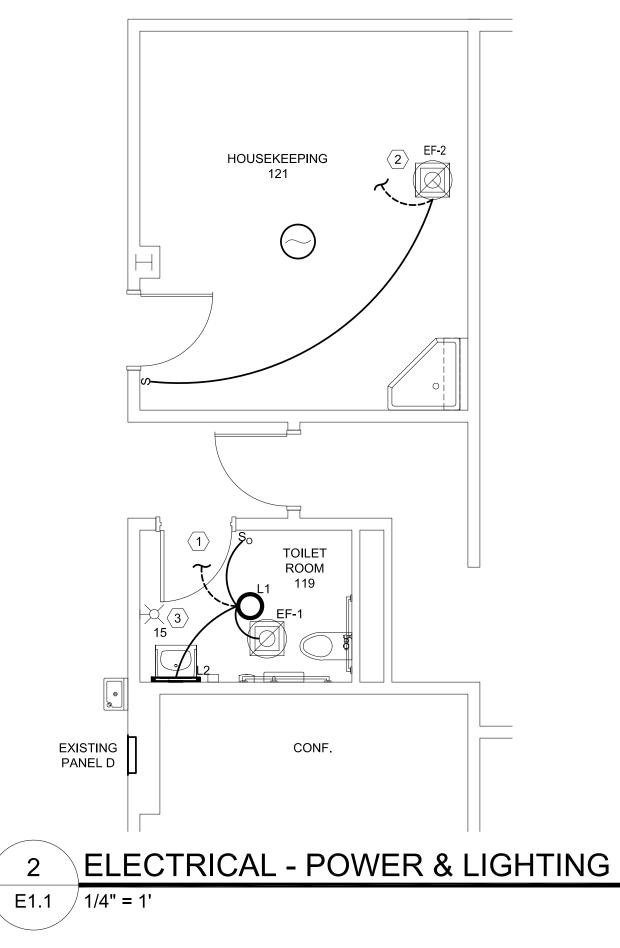

NEW WORK KEYED NOTES

- THE E.C. SHALL PROVIDE NEW OCCUPANCY SENSOR SWITCH AT THE NEW SWITCH LOCATION, NEW LIGHTING FIXTURES AND NEW EXHAUST FAN WIRING. FIELD VERIFY THE LIGHTING CIRCUIT D-7 AND WIRE IN SUCH A MANNER THAT THE EXHAUST FAN IS CONNECTED TO THE LIGHTING FIXTURES AND RUNS SIMULTANEOUSLY. PROVIDE A MINIMUM 15 MINUTE OFF-DELAY TIME SETTING AFTER OCCUPANCY. COORDINATE THE OCCUPANCY SENSOR SETTINGS AND ALL LIGHTING FIXTURE LOCATIONS PRECISELY WITH THE G.C., THE M.C., AND ALL OTHER TRADES PRIOR TO ROUGH-IN.
- THE E.C. SHALL PROVIDE A NEW SWITCH, SWITCH BOX, J-BOXES, EXTENSION BOXES, CONDUIT, CONDUCTORS AND WIRING TO CONTROL THE NEW EXHAUST FAN EF-2. FIELD VERIFY THE LIGHTING CIRCUIT D-7 FOR CONNECTING THE EXHAUST FAN POWER. COORDINATE THE PRECISE RECEPTACLE REQUIREMENTS WITH THE G.C., THE M.C., AND ALL OTHER TRADES PRIOR TO ROUGH-IN.
- THE E.C. SHALL PROVIDE A 15 CANDELA STROBE-ONLY FIRE ALARM SYSTEM ANNUNCIATOR AT 88"AFF COMPATIBLE WITH THE GENERAL ELECTRIC WITH THE WCU SAFETY AND RISK MANAGEMENT OFFICE PRIOR TO COMMENCING WORK. PROVIDE 72 HOURS PRIOR NOTICE TO THE WCU SAFETY AND RISK MANAGEMENT OFFICE AT 828-227-7443 BEFORE COMMENCING ANY CONSTRUCTION ACTIVITY SUCH AS DEMOLITION NEAR EXISTING SMOKE DETECTOR DEVICES OR BEFORE COMMENCING NEW FIRE ALARM WORK. PROVIDE A CONTINUOUS FIRE WATCH DURING ANY FIRE ALARM OUTAGES. PROVIDE NFPA 72 RE-ACCEPTANCE TESTING PER ARTICLE 14.4.2 FOR ALL EXISTING DEVICES REMOVED AND REPLACED; AND 10 PERCENT OF REMAINING EXISTING DEVICES AT RANDOM, PROVIDE WRITTEN TEST RESULT FORMS TO THE OWNER UPON COMPLETION.

SCOPE OF WORK

PROVIDE TEMPORARY CONSTRUCTION PHASE POWER AND LIGHTING FOR ALL TRADES AS REQUIRED TO COMPLETE THE WORK.

THE E.C. SHALL DE-ENERGIZE, LOCK-OUT, TAG-OUT, AND MAKE SAFE ALL EXISTING WIRING AND EQUIPMENT INVOLVED IN DEMOLITION OR WORK BY OTHER

THE E.C. SHALL PROVIDE SUBMITTALS ON ALL POWER, LIGHTING, AND CONTROLS EQUIPMENT FOR REVIEW PRIOR TO PURCHASE.

PROVIDE ALL ELECTRICAL WORK SHOWN ON THE DRAWINGS AND IN THE SPECIFICATIONS AND AS REQUIRED TO PROVIDE A COMPLETELY FUNCTIONAL INSTALLATION IN COMPLIANCE WITH ALL STATE AND LOCAL CODES.

PROVIDE ALL LOW VOLTAGE, DATA WIRING AND OUTLETS SHOWN ON THE DRAWINGS. FOR DATA OUTLETS, PROVIDE A 4X4 METALLIC BOX WITH SINGLE GANG PLASTER RING, STAINLESS STEEL MODULAR DATA OUTLET PLATE WITH 1" MINIMUM CONDUIT STUB-UP ABOVE CEILING WITH PULL STRINGS. PROVIDE RJ-45 JACKS AND TWO CAT6 DATA CABLE HOME RUNS TO THE NEAREST PATCH PANEL. PROVIDE PATCH PANEL CONNECTIONS AND TEST TO 1 GIGABIT PERFORMANCE. PROVIDE WRITTEN TEST RESULTS. PROVIDE IDENTIFICATION WIRE LABELS AT BOTH ENDS AS DIRECTED BY THE OWNER. PROVIDE DATA CABLE HANGERS AT 3' MAXIMUM CENTERS.

PROVIDE FIELD COORDINATION WITH OTHER TRADES AND PROVIDE MARKED UP RED LINE DRAWINGS TO THE OWNER DETAILING ALL FIELD REVISIONS AND

TEST ALL MOTORS FOR THE CORRECT ROTATION. ASSIST IN THE STARTUP AND TESTING OF ALL FIXED EQUIPMENT. COORDINATE WITH THE OTHER TRADES PRECISELY.

TEST ALL LIGHTING, SWITCHING, PHOTOCELLS (DUSK/DAWN CONTROLS), AND OCCUPANCY SENSORS FOR PROPER FUNCTION INCLUDING AN AFTER DARK DEMONSTRATION TO THE OWNER FOR APPROVAL. PROVIDE WRITTEN RECORDS OF LIGHTING PROGRAM SETTINGS.

THE E.C. SHALL ASSIST ALL OTHER TRADES IN TESTING INSTALLED EQUIPMENT.

TEST AND CERTIFY ALL FIRE ALARM EQUIPMENT. PROVIDE NFPA 72 REPORT DOCUMENTS

TEST AND CERTIFY ALL EMERGENCY LIGHTING FOR A 90 MINUTE PERIOD.

PROVIDE ALL REQUIRED ELECTRICAL PERMITS AND INSPECTIONS. NC STATE CONSTRUCTION OFFICE PROJECTS (SCO) SHALL BE COORDINATED A MINIMUM OF ONE WEEK IN ADVANCE, WITH THE SCO ELECTRICAL INSPECTOR:

DAVID SOUTHER 919-427-8589 CELL

919-807-4100 MA**I**N

SCO INSPECTIONS ARE NORMALLY SCHEDULED WEDNESDAYS. DO NOT ENERGIZE NEW OR MODIFIED CIRCUITS BEFORE RECEIVING APPROVAL FROM THE STATE CONSTRUCTION OFFICE STATE ELECTRICAL INSPECTOR.

THE E.C. SHALL PROVIDE A ONE YEAR WARRANTY ON ALL PARTS AND LABOR FROM THE DATE OF PROJECT ACCEPTANCE.

GENERAL NOTES (ALL ELECTRICAL SHEETS)


- 1 ELECTRICAL DRAWINGS ARE DIAGRAMMATIC AND INDICATE THE APPROXIMATE LOCATION OF DEVICES AND EQUIPMENT. THE CONTRACTOR SHALL FIELD VERIFY ALL EXISTING CONDITIONS ON SITE. MINOR ADJUSTMENTS AND OFFSETS SHALL BE PROVIDED WHERE REQUIRED AT NO ADDITIONAL COST TO
- PROVIDE ALL WORK IN COMPLIANCE WITH ALL STATE AND LOCAL CODES AND IN AN INDUSTRY STANDARD WORKMANLIKE MANNER.
- NMC (ROMEX AND SE CABLE FOR FEEDERS) IS NOT ACCEPTABLE. AC/MC CABLE IS ACCEPTABLE FOR FISHING IN EXISTING WALLS IN COMPLIANCE WITH NEC 330.10 AND 330.12.. EMT CONDUITS WITH STEEL COMPRESSION FITTINGS (W/INSULATED THROATS) AND COUPLINGS WITH COPPER CONDUCTORS SHALL BE USED IN EXPOSED LOCATIONS. CONDUIT MINIMUM SIZE IS 3/4".
- UNLESS OTHERWISE NOTED, RACEWAYS SHALL NOT BE RUN ON THE EXTERIOR OF BUILDINGS. RACEWAYS SHALL BE SUPPORTED IN A WORKMANLIKE MANNER AT ADEQUATE INTERVALS FOR EVEN/LEVEL SUPPORT AND TO PREVENT SAGGING.
- ALL WALLS AND PENETRATIONS SHALL BE REPAIRED AND SEALED, SEE THE ARCHITECTURAL DRAWINGS FOR FIRE RATINGS AND WALL CONSTRUCTION
- UNLESS OTHERWISE NOTED: ALL WIRING SHOWN IS COPPER THHN/THWN RATED. ALL WIRES #10 AWG OR SMALLER SHALL BE SOLID CONDUCTORS (NOT STRANDED.)
- WCU CAMPUS STANDARD DEVICES SHALL BE RECEPTACLES-HUBBELL 5352AG (GREY) WITH SS8 STAINLESS STEEL WALLPLATE, GFCI RECEPTACLES-HUBBELL GFR5362GYA(GREY) WITH S26 STAINLESS WALL PLATE, AND SINGLE POLE SWITCH-HUBBELL 1221GY (GREY) WITH SS1 STAINLESS
- ALL SPARE BREAKERS SHALL BE TURNED OFF AND LABELED "SPARE" ON THE DIRECTORY CARD. PROVIDE A TYPE WRITTEN OR COMPUTER PRINTED PANEL SCHEDULE CARD ON HEAVY CARD STOCK PAPER.
- PROVIDE ALL CONDUIT AND WIRE TERMINATIONS TO EQUIPMENT.
- 10 GENERALLY FOCUS EMERGENCY LIGHT HEADS AT 45° DOWN ANGLE AND +/- 15°-45° HORIZONTALLY TO COVER EGRESS PATCH. DO FINAL ADJUSTMENT OF HEADS WITH ENGINEER.
- PRIOR TO LOCATING ANY DEVICES AT CASEWORK, COUNTERTOPS, SINKS, OR ETC COORDINATE WITH OWNER TO VERIFY MOUNTING HEIGHTS AND LOCATIONS. COORDINATE ANY MOUNTING LOCATIONS PRIOR TO ROUGH IN WITH OWNER.
- THE ENGINEER HAS ATTEMPTED TO PROVIDE A COMPLETE DESIGN, COMPLIANT WITH ALL CODES. THE CONTRACTOR REMAINS RESPONSIBLE FOR MINOR ADJUSTMENTS TO COMPLY WITH ALL APPLICABLE CODES AND THE DESIGN INTENT



SUD ASSOCIATES, P.A. CONSULTING ENGINEERS


LICENSE NO. C-0315 PROJECT #NC49X004 1813 CHAPEL HILL ROAD

90 SOUTHSIDE AVE. SUITE 350 **ASHEVILLE, NC 28801** (828) 255-4691

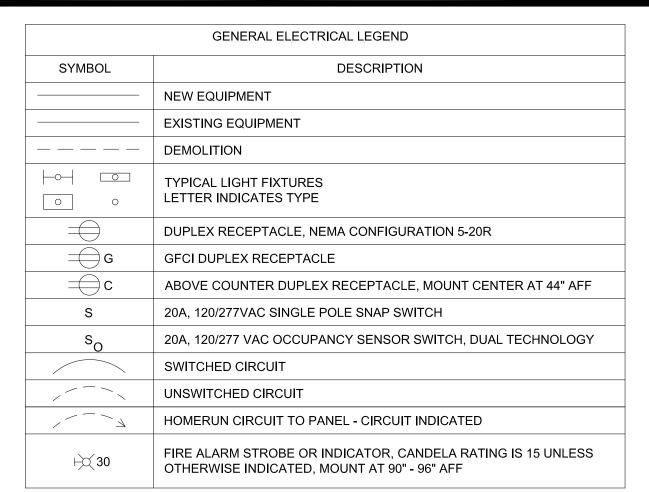

ABBREVIATIONS

| Α | AMP | MCB | MAIN CIRCUIT BREAKER |
|-----|-------------------------------------|-----|--------------------------|
| AFF | ABOVE FINISHED FLOOR | MDS | MAIN DISCONNECT SWITCH |
| AFG | ABOVE FINISHED GRADE | MDP | MAIN DISTRIBUTION PANEL |
| AL | ALUMINUM | N | NEUTRAL |
| BFG | BELOW FINISHED GRADE | NIC | NOT IN CONTRACT |
| С | CONDUIT (AND DEVICE COUNTER HEIGHT) | OEM | ORIGINAL EQUIPMENT MANU. |
| CU | COPPER OR CONDENSING UNIT | PC | PLUMBING CONTRACTOR |
| EC | ELECTRICAL CONTRACTOR | PE | PHOTOCELL |
| EF | EXHAUST FAN | PVC | POLYVINYL CHLORIDE PIPE |
| ER | REMTOE EMERGENCY LIGHT | PNL | PANELBOARD |
| EWH | ELECTRIC WALL HEATER | RSC | RIGID STEEL CONDUIT |
| EX | EXIT SIGN | RTU | ROOF TOP UNIT |
| FMC | FLEXIBLE METAL CONDUIT | SA | SURGE ARRESTER |
| G | GROUND | UON | UNLESS OTHERWISE NOTED |
| GC | GENERAL CONTRACTOR | VAC | VOLTAGE AC |
| GFI | GROUND FAULT INTERRUPTER | W | WET LOCATION RATED |
| MC | MECHANICAL CONTRACTOR | WIR | WIRE (SIZE/RATING) |
| | | | |

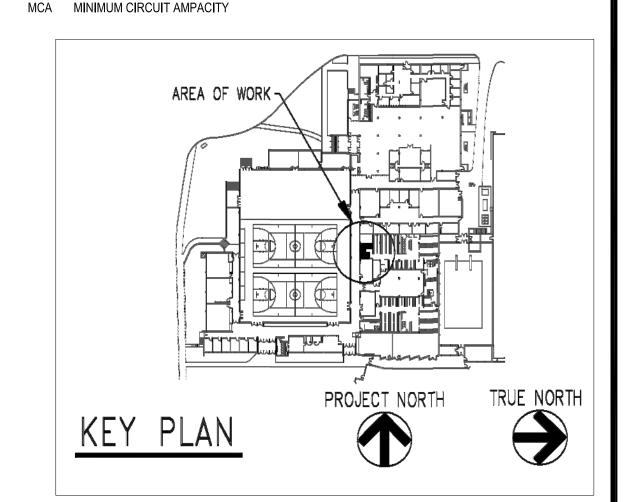


WESTERN CAROLINA UNIVERSITY

CULLOWHEE, NORTH CAROLINA REID GYMNASIUM

REID 119 TOILET ROOM RENOVATION SCO ID #: 23-26576-01A

WCU #: 2023-008

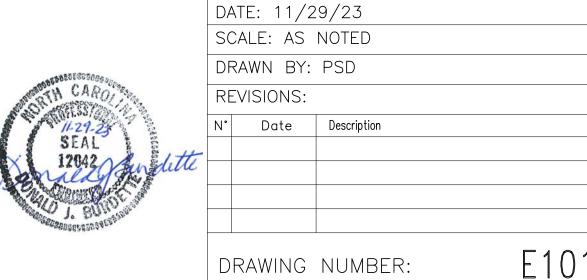

DRAWING NUMBER:

DEMO, NEW PLAN, & SCHEDULE

CONSTRUCTION SET - 11/29/23